



# KNOWLTON FARMS SOLAR DEVELOPMENT 44 ESTABROOK AVENUE [PHASE THREE]

ASSESSOR'S MAP 49 - LOT 6 -APPLICATION FOR SPECIAL PERMIT--APPLICATION FOR SITE PLAN APPROVAL-

PLANS AND DESIGN HAVE BEEN DEVELOPED IN ACCORDANCE WITH THE PERFORMANCE STANDARDS SET FORTH IN SECTION 4.1 OF THE GRAFTON ZONING BYLAW & ARTICLE 36: STORMWATER MANAGEMENT BYLAW





# GRAFTON, MASSACHUSETTS

DATE: JUNE 12, 2018

### APPLICANT:

BLUEWAVE CAPITAL, LLC 137 NEWBURY STREET, FOURTH FLOOR BOSTON, MASSACHUSETTS 02116

### LAND SURVEYOR/SITE CIVIL ENGINEER:



WWW.MERIDIANASSOC.COM

# ENVIRONMENTAL CONSULTANT:

RECORD OWNERS:

KNOWLTON FARMS NOMINEE TRUST

PATRICIA K. KNOWLTON, TRS.

43 ESTABROOK AVENUE

GRAFTON, MASSACHUSETTS 01519

LEC ENVIRONMENTAL CONSULTANTS, INC. 100 GROVE STREET, SUITE 302 WORCESTER, MA 01605 WWW.LECENVIRONMENTAL.COM

## LOCUS CONTEXT MAP:

GRAPHIC SCALE SCALE: 1"=500'

# PROJECT SUMMARY:

THE PROJECT PROPOSES THE INSTALLATION OF 402 SOLAR PANEL TABLES EACH CONTAINING 18 SOLAR PANELS FOR A TOTAL OF 7,236 SOLAR PANELS. THE SOLAR PANELS WILL BE INSTALLED AS AN ELEVATED CANOPY THAT WILL ALLOW AGRICULTURAL ACTIVITIES NAMELY, A COMBINATION OF LIGHT LIVESTOCK AND FOOD CROPS TO CONTINUE UNIMPEDED UNDER THE ARRAY (I.E. "DUAL-USE"). THE SOLAR ENERGY FACILITY WILL PRODUCE APPROXIMATELY 2.9 MEGAWATTS DC (MWDC) OF POWER, AND 2.0 MEGAWATTS AC (MWAC) OF POWER.

## DRAWING INDEX:

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SHEET 12 SITE DETAILS

FOR PERMITTING ONLY, NOT FOR CONSTRUCTION



MASSACHUSETTS HEREBY CERTIFY THAT THE NOTICE OF APPROVAL OF THIS PLAN BY THE GRAFTON PLANNING BOARD HAS BEEN RECEIVED AND RECORDED AT THE OFFICE AND NO NOTICE OF APPEAL WAS RECEIVED DURING TWENTY DAYS NEXT AFTER SUCH RECEIPT AND RECORDING OF

DATE

TOWN CLERK


"THIS PLAN IS SUBJECT TO A SPECIAL PERMIT DATED \_\_\_\_\_" "THIS PLAN IS SUBJECT TO SITE PLAN APPROVAL DATED \_\_\_\_\_

"THIS PLAN IS SUBJECT TO A CERTIFICATE OF OF GOOD STANDING DATED JUNE 5, 2018"

DWG FILE: 6108\_CVR.dwg 9:37am PLOTTED: Jun 12, 2018 dkelley

APPROVED BY:

GRAFTON PLANNING BOARD

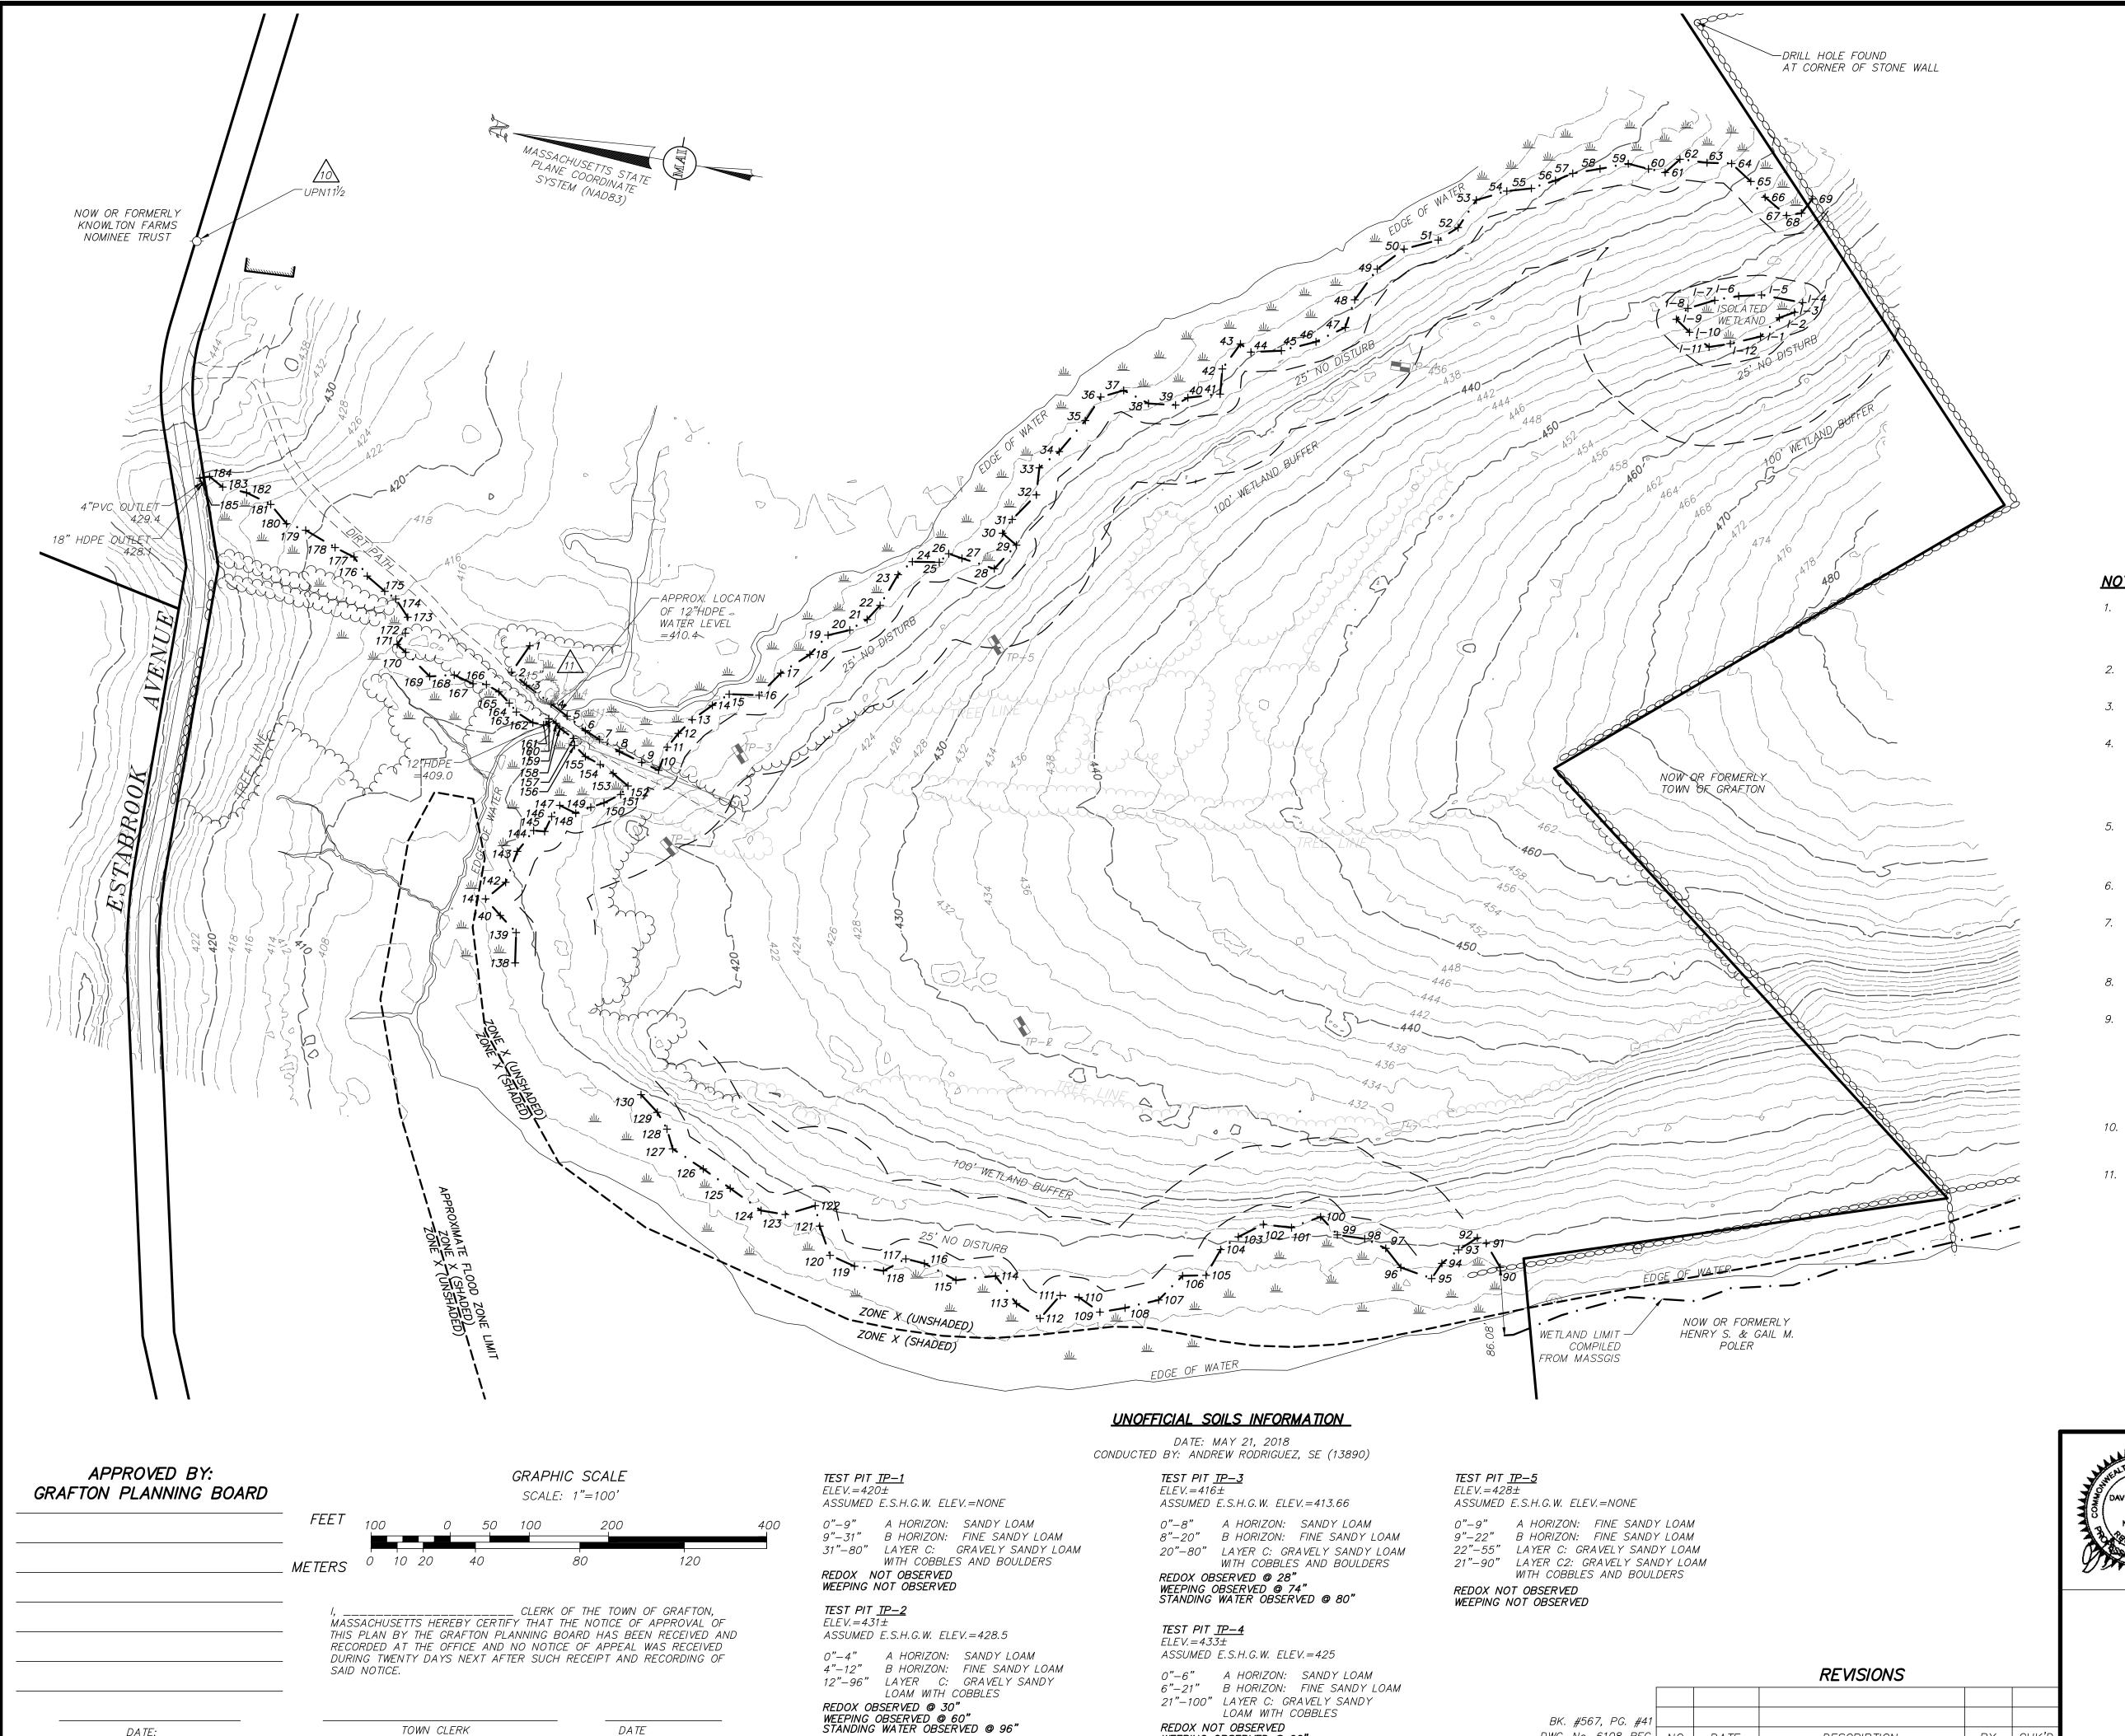

WEEPING OBSERVED @ 96'

DWG FILE: 6108\_REC.dwg 9:37am PLOTTED: Jun 12, 2018 dkelley

#### SCHEDULE OF DIMENSIONAL CONTROLS

ZONING DISTRICT: RESIDENTIAL (R40)

<u>REQU</u>	<u> </u>	<u>REQUIRED</u>	<u>PROPOSED</u>
Lo	OT AREA:	40,000 SF.	7,196,902 SF.
FF	RONTAGE:	140 FT.	6,176 FT.
FROI	NT YARD:	30 FT.	31± FT. (EX. DWELLING)
SIL	DE YARD:	15 FT.	>2,000 FT. (EX. DWELLING)
REA	AR YARD:	15 FT.	166± FT. (SOLAR PANELS)
BUILDING LOT CO	OVERAGE:	30%	0.1%
MAXIMUM BUILDING	HEIGHT:	35 FT.	<35 FT. (EX. DWELLING)

#### SITE FEATURES

----XX---- TWO FOOT CONTOUR -----XX-----FIVE FOOT CONTOUR TREELINE · STONEWALL BORDERING VEGETATED WETLANDS

WETLAND FLAG - - LIMIT OF BUFFER ZONE

#### <u>TEMPORARY BENCHMARK CHART</u>

T.B.M.#	DESCRIPTION	ELE VA TION
10	CUT SPIKE IN UTILITY POLE #11½, 1.5' A.G.	453.08
11	CUT SPIKE IN 15" CONIFEROUS TREE, 1.0' A.G.	413.32

#### (SEE NOTE 6)

#### **NOTES:**

- 1. THE TOPOGRAPHY, SITE DETAIL & SURFACE IMPROVEMENTS DEPICTED HEREON WERE OBTAINED FROM AN AERIAL LIDAR SURVEY CONDUCTED BY MERIDIAN ASSOCIATES, INC. (MAI) ON APRIL 23, 2018 AND SUPPLEMENTED WITH AN ON-THE-GROUND SURVEY CONDUCTED ON JUNE 5, 2018.
- 2. THE SUBJECT PROPERTY IS LOCATED IN THE LOW DENSITY RESIDENTIAL (R-40) ZONING DISTRICT.
- 3. THE SUBJECT PROPERTY IS DEPICTED AS PARCEL ID 110/049.0-0000-0006.0 ON TOWN OF GRAFTON ONLINE ASSESSOR'S DATABASE.
- 4. THE LOCATION OF ALL UNDERGROUND UTILITIES SHOWN ARE APPROXIMATE AND ARE BASED UPON A PARTIAL FIELD SURVEY AND COMPILATION OF PLANS OF RECORD. MERIDIAN ASSOCIATES, INC. DOES NOT WARRANTY NOR GUARANTEE THE LOCATION OF ALL UTILITIES DEPICTED OR NOT DEPICTED. THE CONTRACTOR, PRIOR TO COMMENCEMENT OF CONSTRUCTION, SHALL VERIFY THE LOCATION OF ALL UTILITIES AND CONTACT DIG SAFE AT 1-888-344-7233.
- 5. THIS PLAN DOES NOT SHOW ANY UNRECORDED OR UNWRITTEN EASEMENTS WHICH MAY EXIST. A REASONABLE AND DILIGENT ATTEMPT HAS BEEN MADE TO OBSERVE ANY APPARENT, VISIBLE USES OF THE LAND; HOWEVER, THIS DOES NOT CONSTITUTE A GUARANTEE THAT NO SUCH EASEMENTS EXIST.
- 6. THE ELEVATIONS DEPICTED HEREON ARE BASED UPON NORTH AMERICAN VERTICAL DATUM OF 1988 (NAVD88).
- 7. PROPERTY LINES DEPICTED HEREON ARE BASED ON COMPILED DEEDS AND PLANS OF RECORD. THIS PLAN IS NOT TO BE USED FOR THE RECONSTRUCTION OF BOUNDARY LINES OR FOR TITLE INSURANCE PURPOSES. ALL BOUNDARY LINES DEPICTED ARE APPROXIMATE ONLY. MAI DID NOT PERFORM A BOUNDARY RETRACEMENT SURVEY.
- 8. THE WETLAND FLAGS DEPICTED WERE DEMARCATED BY LEC ENVIRONMENTAL CONSULTANTS, INC. ON APRIL 2 & 3, 2018.
- 9. THE SUBJECT PROPERTY IS LOCATED IN FLOOD ZONE X (UNSHADED), AREAS DETERMINED TO BE OUTSIDE THE 0.2% ANNUAL CHANCE FLOODPLAIN, AND FLOOD ZONE X (SHADED), MODERATE RISK AREAS WITHIN THE 0.2% CHANCE FLOODPLAIN, AREAS OF 1% ANNUAL CHANCE FLOODING WHERE AVERAGE DEPTHS ARE LESS THAN 1 FOOT, AREAS OF THE 1% ANNUAL CHANCE FLOOD WHERE THE CONTRIBUTING DRAINAGE AREA IS LESS THAN 1 SQUARE MILE, AND AREAS PROTECTED FROM THE 1% ANNUAL CHANCE FLOOD BY A LEVEE PER FEMA FLOOD INSURANCE RATE MAP NUMBER 25027C0831E DATED JULY 4, 2011.
- 10. THE SUBJECT SITE IS LOCATED WITHIN THE MISCOE, WARREN AND WHITEHALL WATERSHEDS AREA OF CRITICAL AND ENVIRONMENTAL CONCERN AS DESIGNATED BY THE MASSACHUSETTS DEPARTMENT OF CONSERVATION AND RECREATION.
- 11. THE EXISTING SITE IS COMPRISED OF WOODLAND AND AGRICULTURAL FIELDS AND IS PRESENTLY USED FOR AGRICULTURAL PURPOSES.

ALL UNDERGROUND UTILITY DATA REPRESENTS RECORD INFORMATION RECOVERED THROUGH RESEARCH WITHOUT SURFACE DEMARCATION NOR SUBSURFACE VERIFICATION

### **RECORD OWNER:**

KNOWLTON FARMS NOMINEE TRUST LEEROY E. KNOWLTON, TRUSTEE 43 ESTABROOK AVENUE GRAFTON, MASSACHUSETTS 01519

- DEED BOOK 35401 PAGE 337

# 44 ESTABROOK AVENUE



DWG. No. 6108\_REC NO. DATE

DESCRIPTION

BY CHK'E

CONDITIONS PLAN OF LAND LOCATED IN GRAFTON, MASSACHUSETTS (WORCESTER COUNTY)

PREPARED FOR BLUEWAVE CAPITAL, LLC


SCALE: 1" = 100"

DATE: JUNE 12, 2018



BEVERLY, MASSACHUSETTS 01915 WESTBOROUGH, MASSACHUSETTS 01581 TELEPHONE: (508) 871-7030

SHEET No. 2 OF 12

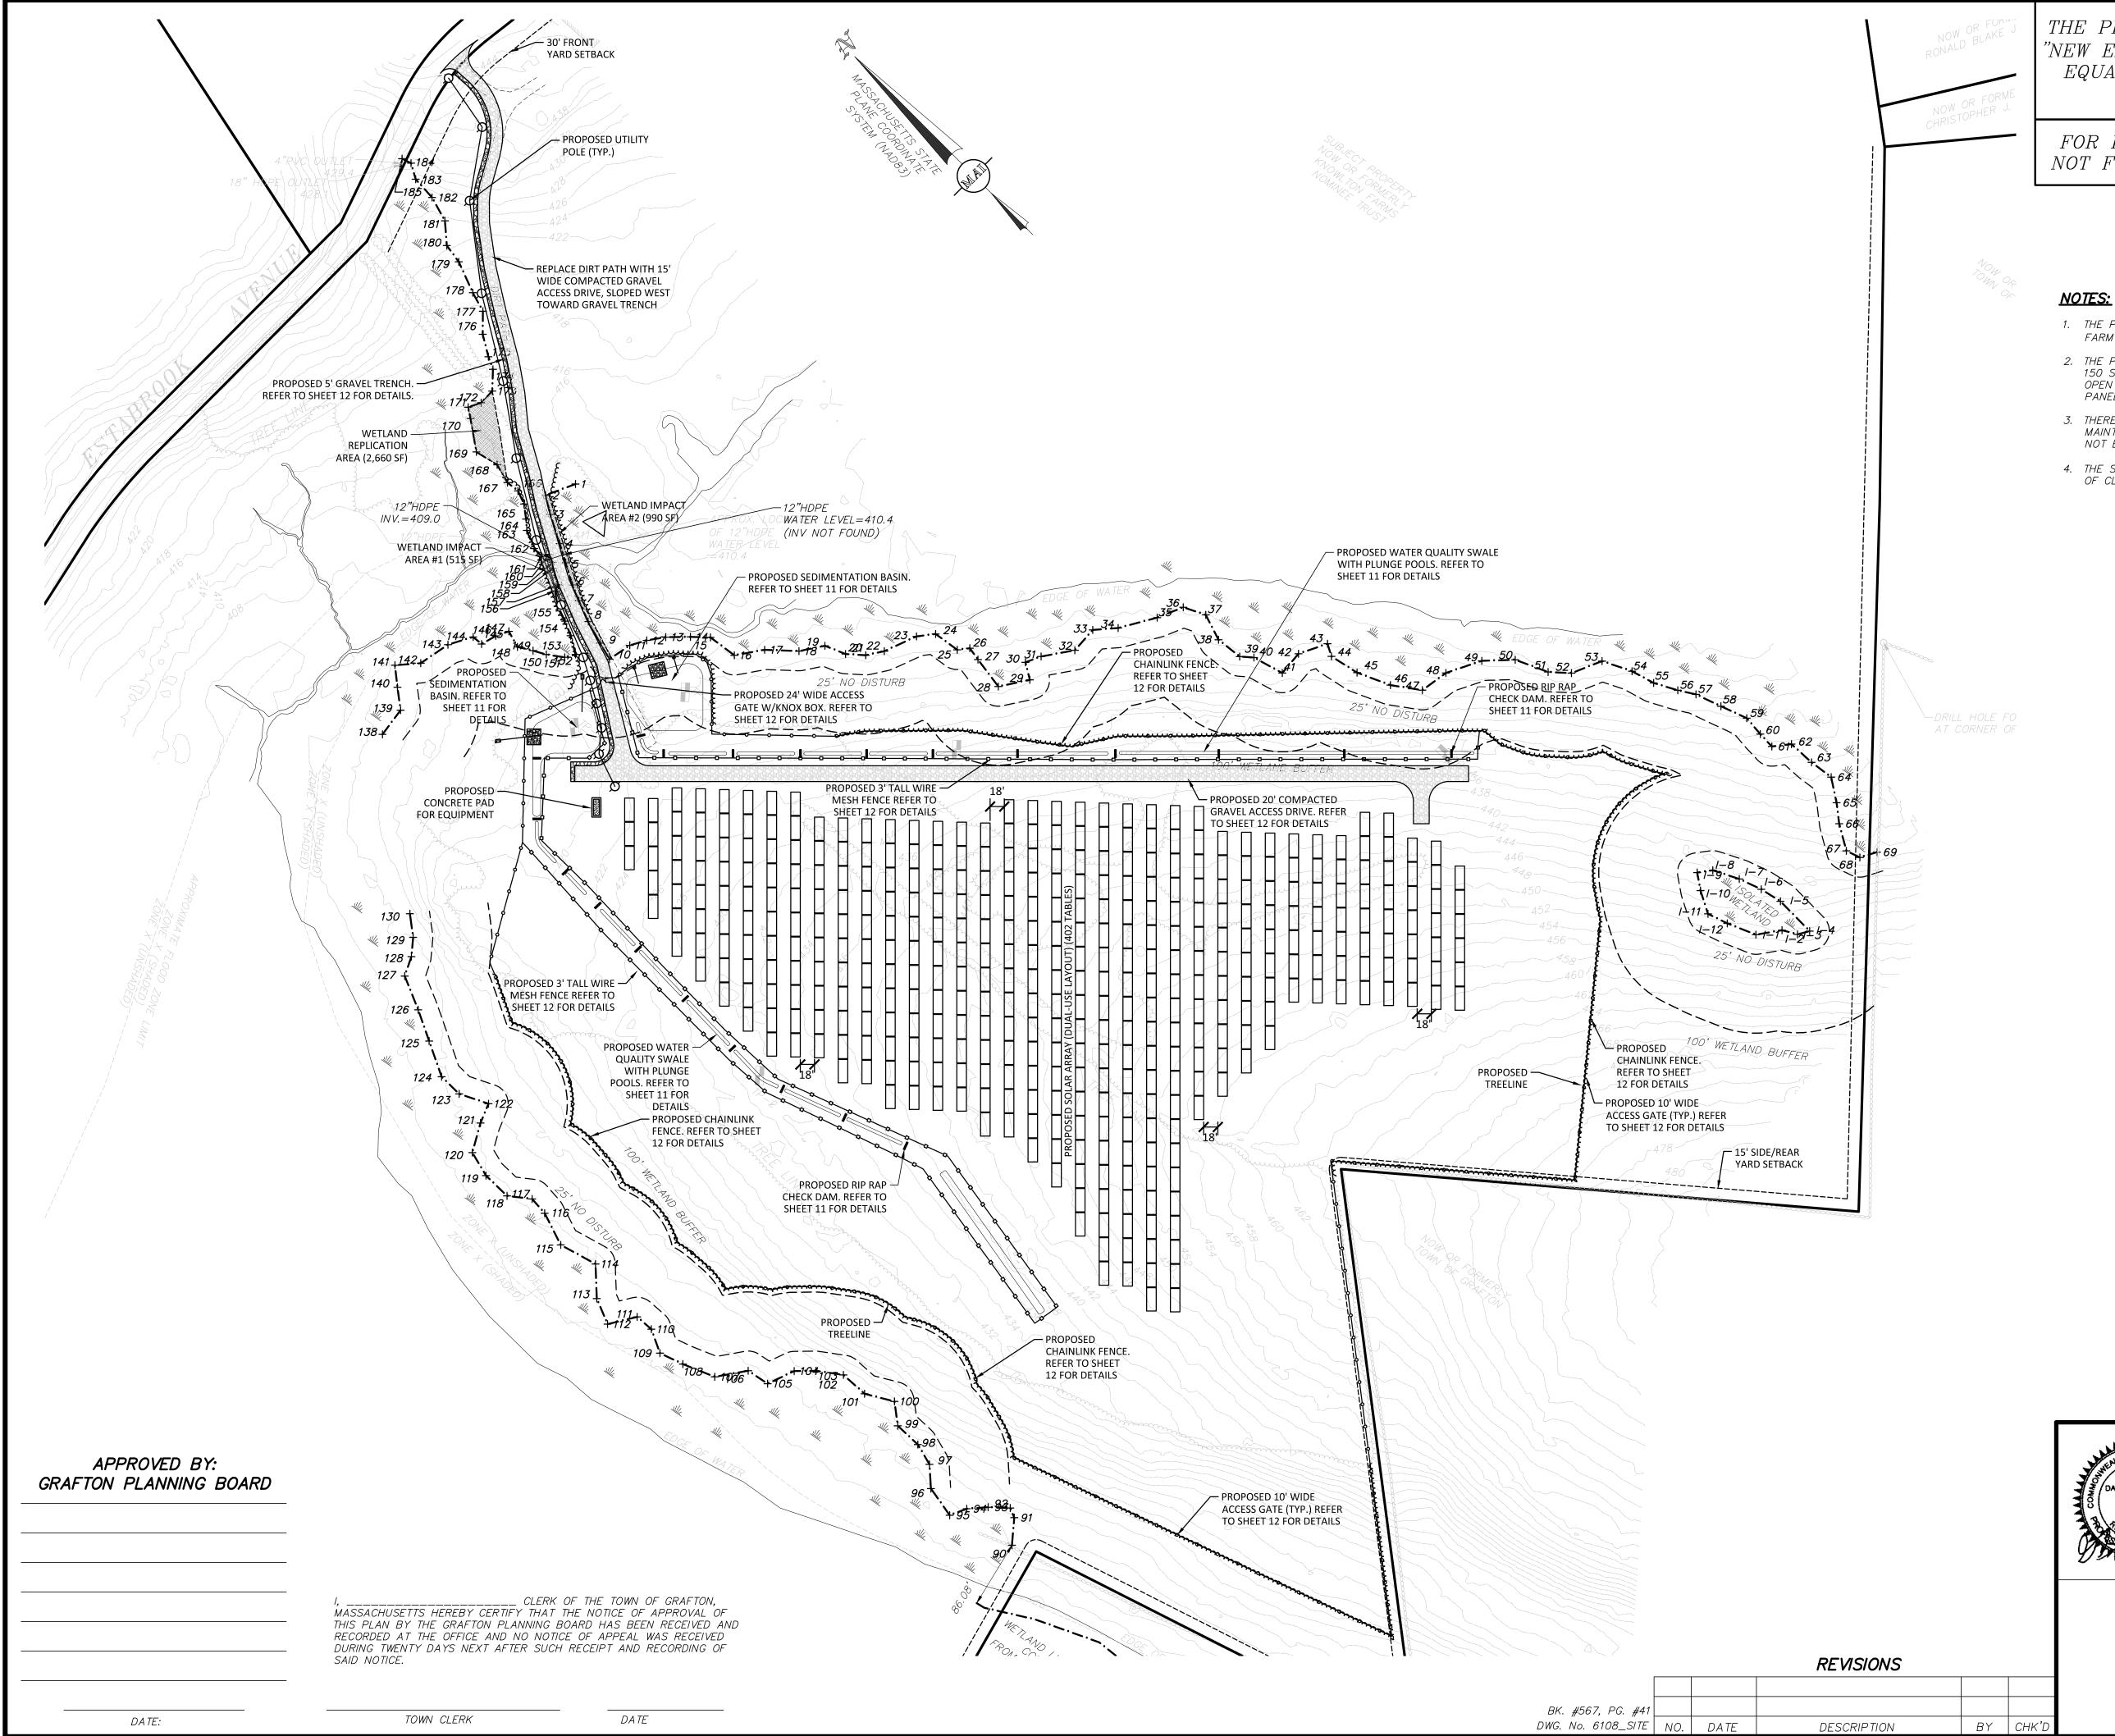

THE PROPOSED ACCESS PATHS SHALL BE VEGETATED USING "NEW ENGLAND CONSERVATIONS/WILDLIFE MIX", OR APPROVED EQUAL, AND IS INTENDED TO PROVIDE A LEVEL PATH OF TRAVEL FOR MAINTENANCE VEHICLES

FOR PERMITTING ONLY NOT FOR CONSTRUCTION

SEE SHEET 2 OF 12 FOR GENERAL NOTES AND LEGEND

MODULES	DC POWER
7,236	2.9±MW

- 1. THE PROPOSED PROJECT WILL CONSIST OF A LARGE SCALE GROUND MOUNTED SOLAR FARM WITH AGRICULTURAL USES I.E. "DUAL-USE".
- 2. THE PROPOSED PROJECT DOES NOT INCLUDED IMPERVIOUS AREAS OTHER THAN THE 150 SF CONCRETE PAD FOR THE ELECTRICAL EQUIPMENT. THE SITE IS PRESENTLY OPEN SPACE, AND WILL REMAIN AS OPEN SPACE WITH GROUND MOUNTED SOLAR
- 3. THERE IS NO PROPOSED PARKING AS THE SITE WILL ONLY BE ACCESSED FOR MAINTENANCE AND REPAIRS TO THE SOLAR PANELS AND EQUIPMENT. THERE WILL NOT BE PERSONAL ONSITE ON A REGULAR BASIS.
- 4. THE SOLAR PANEL TABLES ARE TO BE LAID OUT AS TO PROVIDE EIGHTEEN (18) FEET OF CLEAR SPACE BETWEEN EACH ROW.

#### **LEGEND:**

<i>710</i>	EXPOSED ROCK OUTCROP
	SPOIL PILE
-	SIGN
	WITNESS POST
	SHRUB
A CONTRACTOR OF THE PROPERTY O	TREE
——————————————————————————————————————	BORDERING VEGETATED WETLANDS WETLAND FLAG -LIMIT OF BUFFER ZONE -OVERHEAD WIRES -ELECTRIC LINE UTILITY POLE GUY WIRE ELECTRIC BOX DRAIN MANHOLE CATCH BASIN BOULDER TERMINUS UNKNOWN BITUMINOUS BERM BITUMINOUS CONCRETE CONCRETE CURB EDGE OF PAVEMENT GRANITE CURB UNDERGROUND ELECTRIC

### PROPOSED LEGEND:

PROPOSED PROPOSED PROPOSED PROPOSED PROPOSED	CONTOUR CHAINLINK FENCE WIRE MESH FENCE
——POHW——PROPOSED	UNDERGROUND ELECTRIC LINE OVERHEAD WIRES UTILITY POLE

GRAPHIC SCALE SCALE: 1"=100' 0 50 100 200

44 ESTABROOK AVENUE

PERMIT SITE PLAN OF LAND (DUAL-USE)

# GRAFTON, MASSACHUSETTS

(WORCESTER COUNTY)

PREPARED FOR

BLUEWAVE CAPITAL, LLC SCALE: 1"= 100'




DATE: JUNE 12, 2018



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SHEET No. 3 OF 12

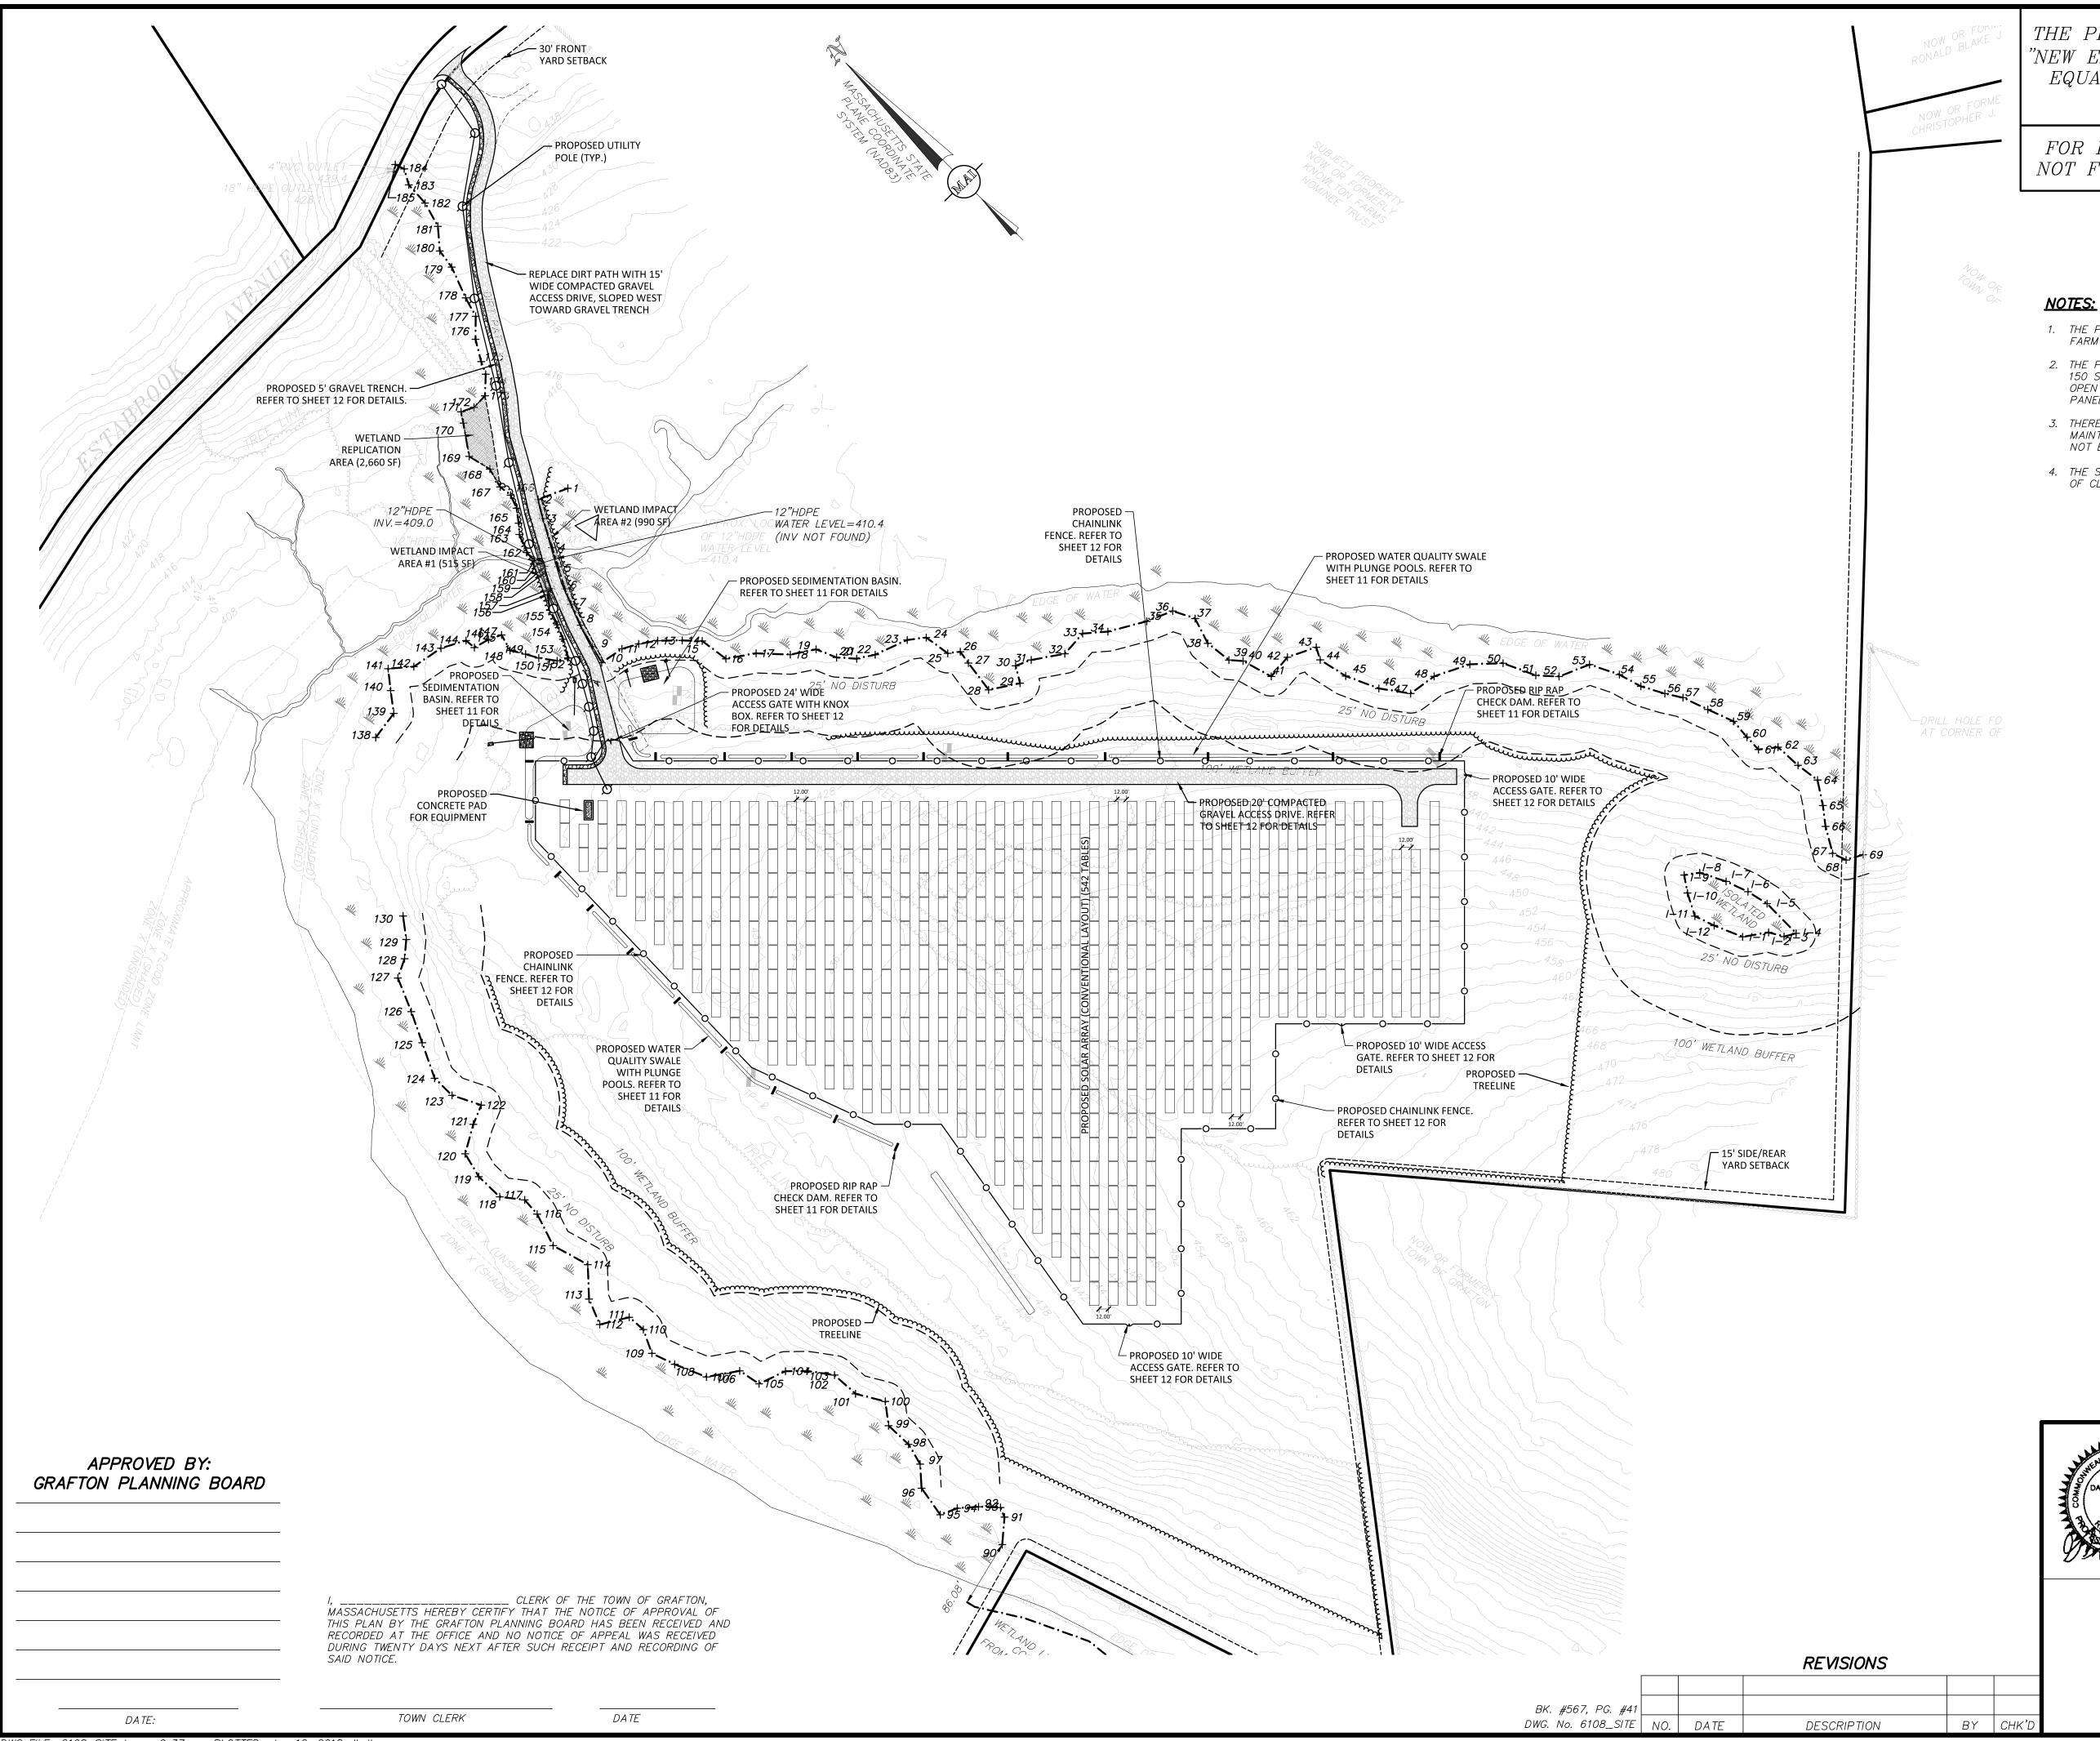

THE PROPOSED ACCESS PATHS SHALL BE VEGETATED USING "NEW ENGLAND CONSERVATIONS/WILDLIFE MIX", OR APPROVED EQUAL, AND IS INTENDED TO PROVIDE A LEVEL PATH OF TRAVEL FOR MAINTENANCE VEHICLES

FOR PERMITTING ONLY NOT FOR CONSTRUCTION

SEE SHEET 2 OF 12 FOR GENERAL NOTES AND LEGEND

MODULES DC POWER  $3.9\pm MW$ 

- 1. THE PROPOSED PROJECT WILL CONSIST OF A LARGE SCALE GROUND MOUNTED SOLAR FARM WITH A CONVENTIONAL LAYOUT.
- 2. THE PROPOSED PROJECT DOES NOT INCLUDED IMPERVIOUS AREAS OTHER THAN THE 150 SF CONCRETE PAD FOR THE ELECTRICAL EQUIPMENT. THE SITE IS PRESENTLY OPEN SPACE, AND WILL REMAIN AS OPEN SPACE WITH GROUND MOUNTED SOLAR
- 3. THERE IS NO PROPOSED PARKING AS THE SITE WILL ONLY BE ACCESSED FOR MAINTENANCE AND REPAIRS TO THE SOLAR PANELS AND EQUIPMENT. THERE WILL NOT BE PERSONAL ONSITE ON A REGULAR BASIS.
- 4. THE SOLAR PANEL TABLES ARE TO BE LAID OUT AS TO PROVIDE TWELVE (12) FEET OF CLEAR SPACE BETWEEN EACH ROW.

#### **LEGEND:**


	- TWO FOOT CONTOUR - TEN FOOT CONTOUR = BITUMINOUS BERM ■ GRANITE CURB = CONCRETE CURB  □ TREELINE □ SCRUB LINE □ STEEL GUARDRAIL □ WIRE FENCE REMAINS □ STONEWALL □ EXPOSED ROCK OUTCROP □ SPOIL PILE SIGN WITNESS POST SHRUB
HA14	TREE  BORDERING VEGETATED WETLANDS  WETLAND FLAG  - LIMIT OF BUFFER ZONE  - OVERHEAD WIRES  - ELECTRIC LINE  UTILITY POLE  GUY WIRE  ELECTRIC BOX  DRAIN MANHOLE  CATCH BASIN  BOULDER  TERMINUS UNKNOWN  BITUMINOUS BERM  BITUMINOUS CONCRETE  CONCRETE CURB  EDGE OF PAVEMENT  GRANITE CURB  UNDERGROUND ELECTRIC

### PROPOSED LEGEND:

PROPOSED TREELINE PROPOSED CHAINLINK FENCE
PROPOSED WIRE MESH FENCE PROPOSED UTILITY POLE

GRAPHIC SCALE SCALE: 1"=100' 0 50 100

44 ESTABROOK AVENUE

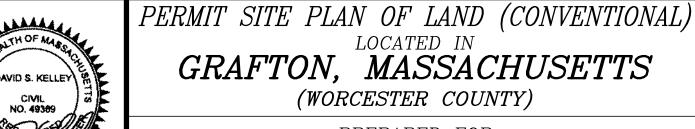

PREPARED FOR


BLUEWAVE CAPITAL, LLC SCALE: 1"= 100'



DATE: JUNE 12, 2018

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SHEET No. 4 OF 12

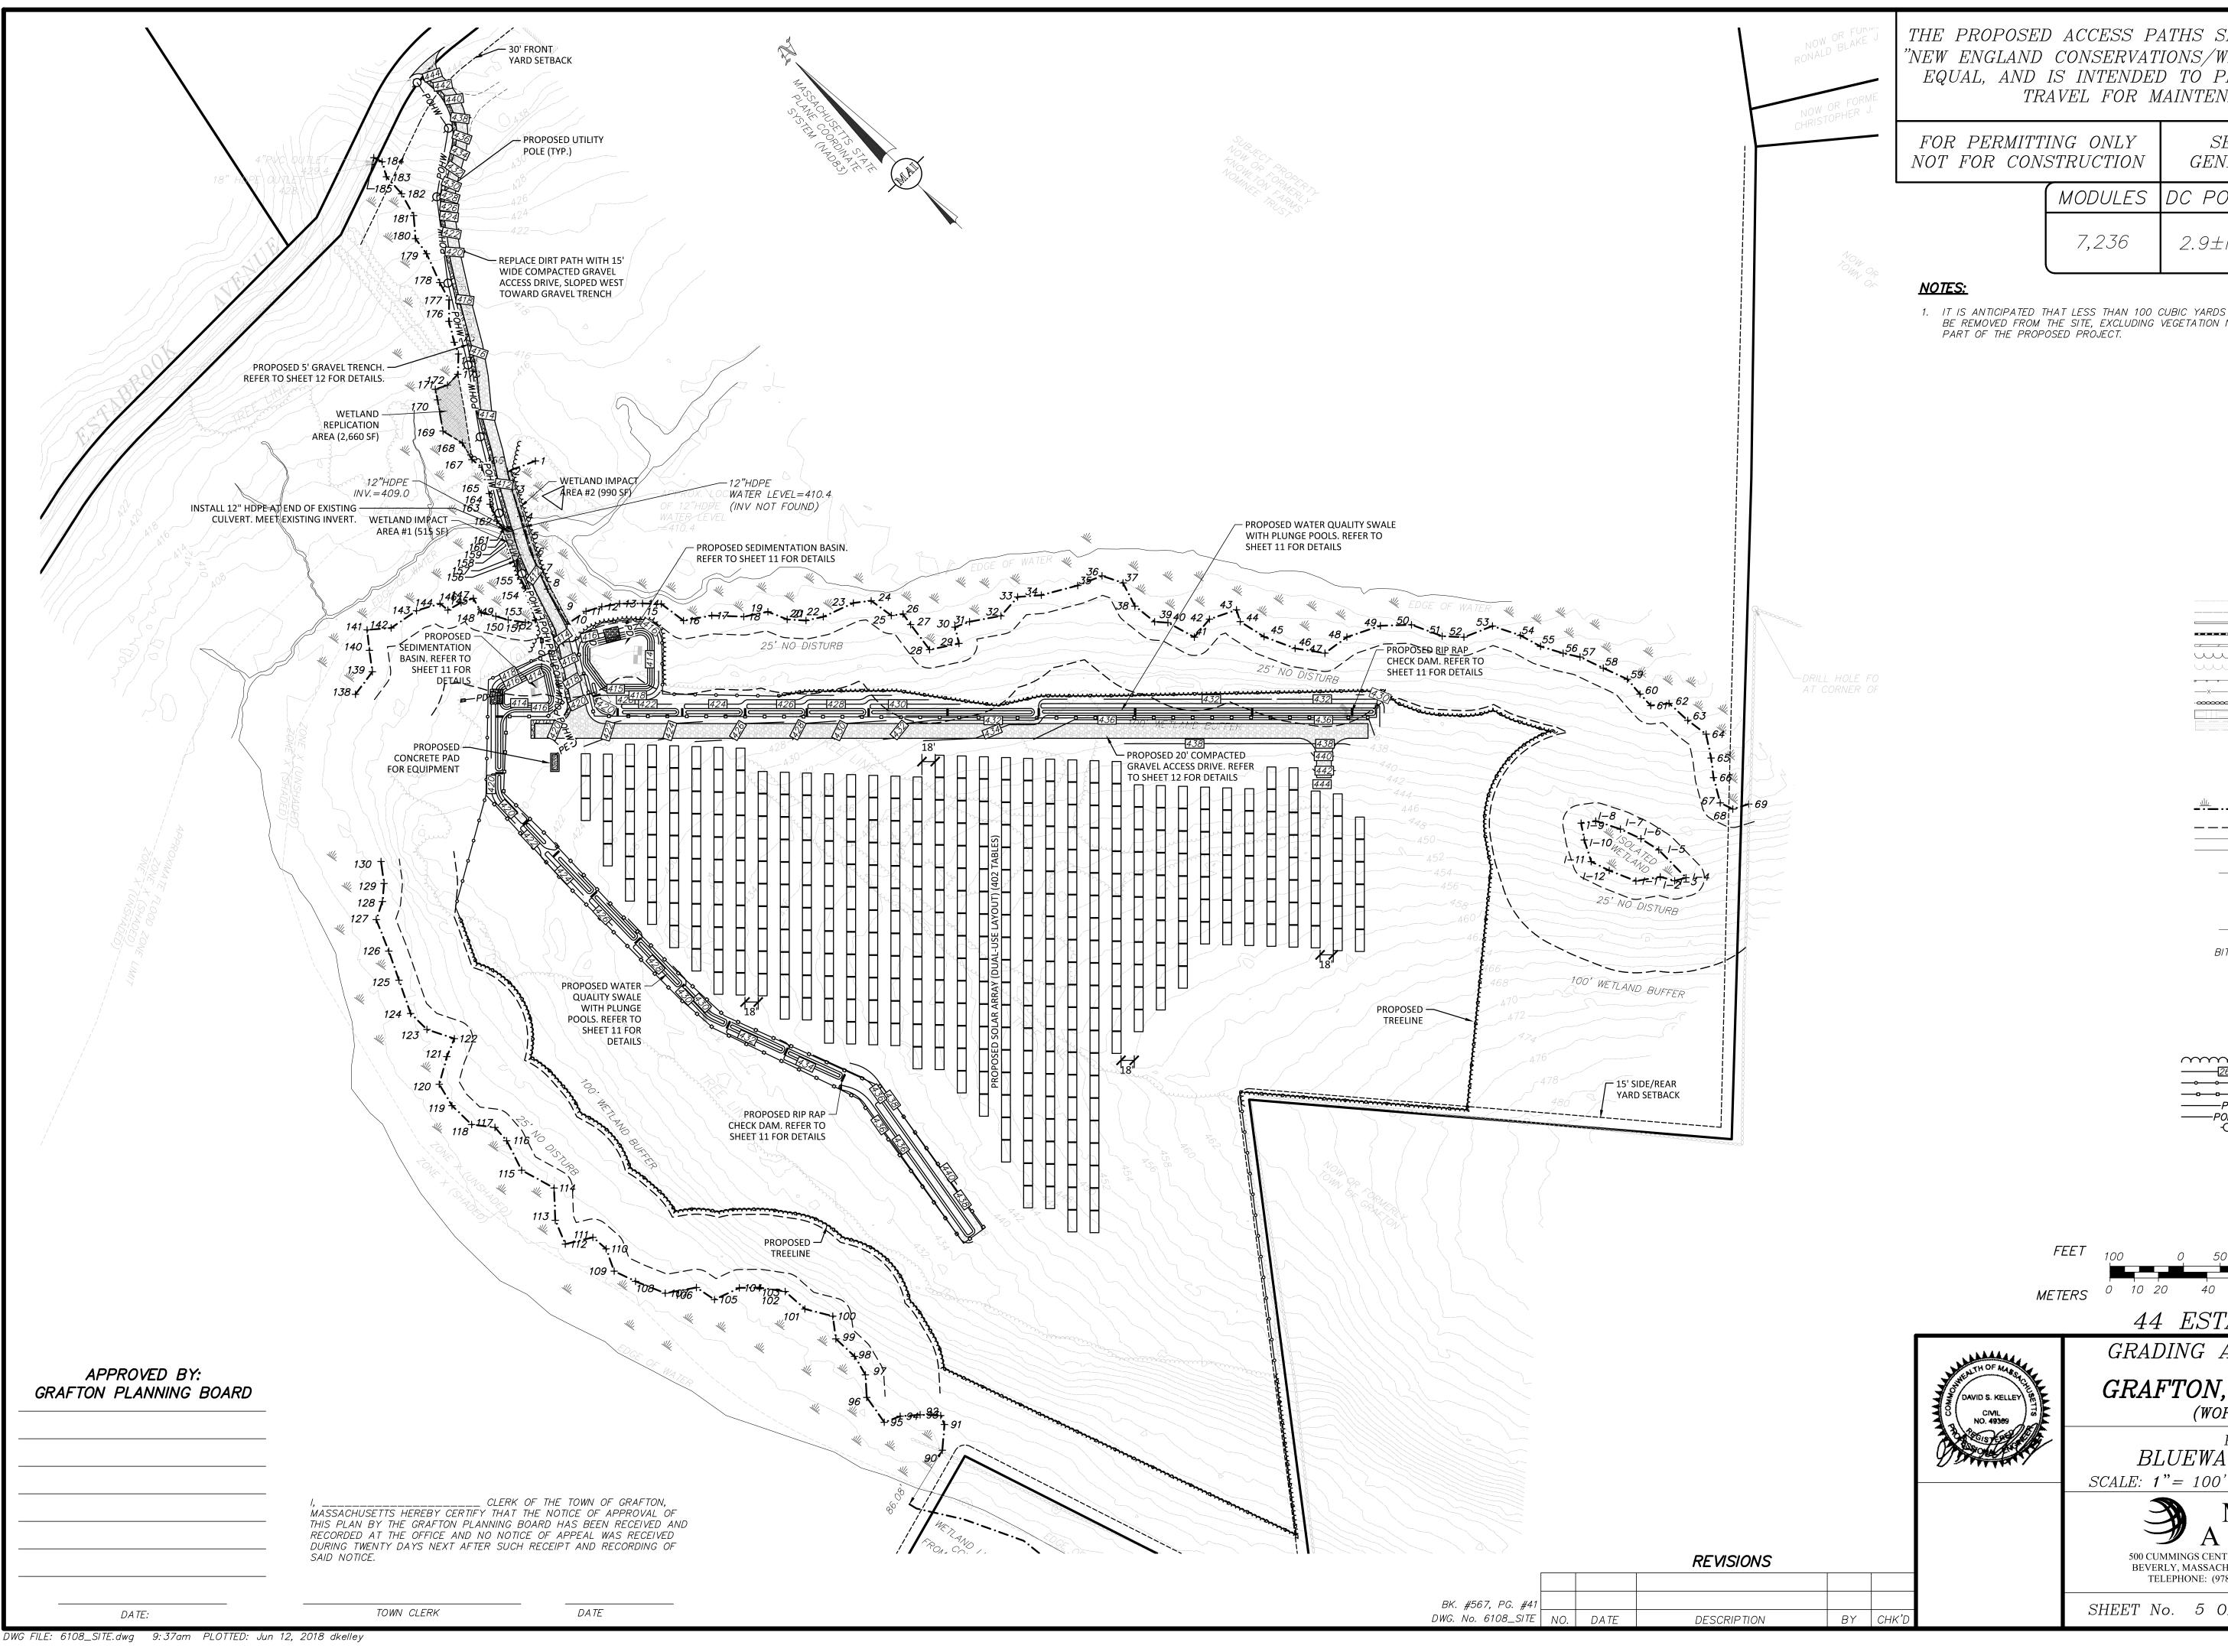

THE PROPOSED ACCESS PATHS SHALL BE VEGETATED USING "NEW ENGLAND CONSERVATIONS/WILDLIFE MIX", OR APPROVED EQUAL, AND IS INTENDED TO PROVIDE A LEVEL PATH OF TRAVEL FOR MAINTENANCE VEHICLES

> SEE SHEET 2 OF 12 FOR GENERAL NOTES AND LEGEND

MODULES	DC POWER
7,236	2.9±MW

1. IT IS ANTICIPATED THAT LESS THAN 100 CUBIC YARDS OF MATERIAL WILL NEED TO BE REMOVED FROM THE SITE, EXCLUDING VEGETATION NEEDED TO BE REMOVED AS A


#### **LEGEND:**

710	TWO FOOT CONTOUR  TEN FOOT CONTOUR  BITUMINOUS BERM  GRANITE CURB  CONCRETE CURB  TREELINE  SCRUB LINE  STEEL GUARDRAIL  WIRE FENCE REMAINS  STONEWALL  EXPOSED ROCK OUTCROP  SPOIL PILE  SIGN  WITNESS POST  SHRUB
Common Constitution of the	TREE
## . ## . ## . ## . ## . ## . ## . ##	BORDERING VEGETATED WETLANDS WETLAND FLAG -LIMIT OF BUFFER ZONE -OVERHEAD WIRES -ELECTRIC LINE UTILITY POLE GUY WIRE ELECTRIC BOX DRAIN MANHOLE CATCH BASIN BOULDER TERMINUS UNKNOWN BITUMINOUS BERM BITUMINOUS CONCRETE CONCRETE CURB EDGE OF PAVEMENT GRANITE CURB UNDERGROUND ELECTRIC

### PROPOSED LEGEND:

PROPOSED TREELINE
PROPOSED CONTOUR
PROPOSED CHAINLINK FENCE
PROPOSED WIRE MESH FENCE 

> GRAPHIC SCALE SCALE: 1"=100'

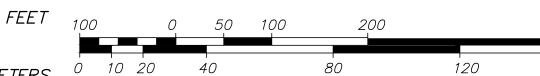

44 ESTABROOK AVENUE

GRADING AND DRAINAGE PLAN

GRAFTON, MASSACHUSETTS

(WORCESTER COUNTY)


PREPARED FOR BLUEWAVE CAPITAL, LLC DATE: JUNE 12, 2018





BEVERLY, MASSACHUSETTS 01915 WESTBOROUGH, MASSACHUSETTS 01581


SHEET No. 5 OF 12


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- 1. EXISTING GROUND WITHIN THE PROPOSED CHAINLINK FENCE SHALL BE CLEARED, STUMPED AND RE-GRADED TO FLIMINATE MINOR SURFACE DISTURBANCES. RE-VEGETATION OF THE SITE SHALL BE ESTABLISHED WITH LOW GROWTH GROUND COVER.
- 2. THE PROPOSED LIMIT OF WORK LINE ALSO DEPICTS THE EXTENT OF TREE CLEARING TO BE PERFORMED ON THE PROJECT SITE. NO TREES OUTSIDE THE DESIGNATED LIMIT OF WORK LINE ARE TO BE REMOVED BY THE CONTRACTOR.
- COMMON FILL (SITE GRADING AREAS) SHALL CONSIST OF MINERAL SOIL SUBSTANTIALLY FREE FROM ORGANIC MATERIALS, LOAM, WOOD TRASH AND OTHER OBJECTIONABLE MATERIALS WHICH MAY BE COMPRESSIBLE OR WHICH CANNOT BE PROPERLY COMPACTED. SELECT COMMON FILL SHALL NOT CONTAIN STONES LARGER THAN 2-IN. IN LARGEST DIAMETER AND SHALL HAVE A MAXIMUM OF 75% PASSING THE NO. 40 SIEVE AND A MAXIMUM OF 20% PASSING THE NO. 200 SIEVE. SELECT COMMON FILL SHALL NOT CONTAIN GRANITE BLOCKS, BROKEN CONCRETE, MASONRY RUBBLE OR OTHER SIMILAR MATERIALS. IT SHALL HAVE PHYSICAL PROPERTIES SUCH THAT IT CAN BE READILY SPREAD AND COMPACTED DURING FILLING. SNOW, ICE AND FROZEN SOIL WILL NOT BE PERMITTED. SOIL EXCAVATED FROM THE STRUCTURE AREAS AND WHICH MEETS THE ABOVE REQUIREMENTS MAY BE USED.
- ORDINARY FILL SHALL BE WELL GRADED, NATURAL INORGANIC SOIL, FREE OF ORGANIC OR OTHER WEAK OR COMPRESSIBLE MATERIALS, FROZEN MATERIALS, AND OF STONES LARGER THAN TWO THIRDS (3/3) THE LIFT THICKNESS. IT SHALL BE OF SUCH NATURE AND CHARACTER THAT IT CAN BE COMPACTED TO THE SPECIFIED DENSITIES IN A REASONABLE LENGTH OF TIME. IT SHALL BE FREE OF PLASTIC CLAY, OF ALL MATERIALS SUBJECT TO DECAY, DECOMPOSITION, OR DISSOLUTION, AND OF CINDERS OR OTHER MATERIALS THAT WILL CORRODE PIPING OR OTHER METAL. IT SHALL HAVE A MINIMUM DRY DENSITY OF NOT LESS THAN 120 POUNDS PER CUBIC FOOT. MATERIAL FROM EXCAVATION ON THE SITE MAY BE USED AS ORDINARY FILL IF IT MEETS THE ABOVE REQUIREMENTS. ORDINARY FILL SHALL HAVE A MAXIMUM OF 60% PASSING THE #40 SIEVE, AND A MAXIMUM OF 20% PASSING THE #200 SIEVE. IT SHOULD NOT CONTAIN BROKEN CONCRETE, MASONRY RUBBLE OR OTHER SIMILAR MATERIALS. AND SHALL HAVE PHYSICAL PROPERTIES SUCH THAT IT CAN BE READILY SPREAD AND COMPACTED DURING FILLING. SNOW, ICE AND FROZEN SOIL SHALL NOT BE PERMITTED.
- SELECT COMMON FILL (ROADWAY AREAS) SHALL BE PLACED IN LAYERS HAVING A MAXIMUM THICKNESS OF 8 IN. MEASURED BEFORE COMPACTION. EACH LAYER OF FILL SHALL BE COMPACTED TO AT LEAST 95 PERCENT OF MAXIMUM DRY DENSITY DETERMINED BY THE ASTM D1557. COMPACTION OF STRUCTURAL FILL SHALL CONSIST OF FULLY LOADED TEN WHEEL TRUCKS, A TRACTOR DOZER WEIGHING AT LEAST 30,000 LBS AND OPERATED AT FULL SPEED. A HEAVY VIBRATORY ROLLER. OR OTHER METHOD ONLY AS APPROVED BY THE ENGINEER. COMPACTION OF SELECT COMMON FILL IN CONFINED AREAS ADJACENT TO STRUCTURES SHALL BE ACCOMPLISHED BY HAND OPERATED VIBRATORY EQUIPMENT OR MECHANICAL TAMPERS APPROVED BY THE ENGINEER. AS A MINIMUM, COMPACTION OF SELECT COMMON FILL SHALL CONSIST OF FOUR COVERAGES OF THE APPROVED EQUIPMENT.
- 6. SITE PREPARATION SHALL INCLUDE CLEARING, GRUBBING, DELETERIOUS SOILS, VEGETATION AND DEBRIS. ALL TREES, STUMPS, BRUSH, SHRUBS, ROOTS, GRASS, WEEDS, RUBBISH, STONES LARGER THAN 2-IN. IN THE LARGEST DIAMETER AND OTHER OBJECTIONABLE MATERIAL SHALL BE REMOVED AND DISPOSED OF FROM AREAS TO BE FILLED AND COMPACTED. AREAS OUTSIDE OF THE LIMITS OF WORK SHALL BE PROTECTED FROM DAMAGE AND NO EQUIPMENT OR MATERIALS SHALL BE STORED IN THESE AREAS. NO STUMPS, TREES, LIMBS, OR BRUSH SHALL BE BURIED IN ANY FILLS OR EMBANKMENTS.
- EROSION AND SEDIMENT CONTROL, BOTH DURING AND AFTER CONSTRUCTION, SHALL BE PROVIDED AS REQUIRED TO RETAIN SEDIMENT ONSITE, AND TO CONTROL EROSION OF EMBANKMENTS, TEMPORARY AND FINAL EXPOSED SLOPES, AND TEMPORARY MATERIAL STOCKPILE(S). SILT FENCES, CHECK DAMS, DRAINAGE DITCHES OR SWALES, TEMPORARY SEEDING, AND PRE-MANUFACTURED TEXTILES, GEOTUBES, GEOGRID, CELLULAR GEOWEB, ETC., SHALL BE UTILIZED AS APPROPRIATE. EROSION AND SETTLEMENT CONTROL MEASURES SHALL BE IN ACCORDANCE WITH ALL PERMITS AND CODES AND THIS SPECIFICATION. DURING THE EXCAVATION OF THE WORK AT THE SITE, OPERATIONS SHALL BE CONTINUOUSLY MONITORED TO AVOID THE CREATION OF CONDITIONS THAT COULD LEAD TO EXCESSIVE EROSION OF SOIL WITH SURFACE RUNOFF FROM THE WORK AREAS. CONTROLS SHALL BE PROVIDED TO PROTECT THE WATER QUALITY AND SHALL BE IN ACCORDANCE WITH PROJECT DOCUMENTS AND ALL LOCAL, STATE AND FEDERAL LAWS AND REGULATIONS. EROSION CONTROL MEASURES SHALL BE EMPLOYED TO REDUCE EROSION OF SLOPES AND SILTATION OF OFF-SITE OUTFALLS AND TRIBUTARIES.
- 8. UPON SIGNS OF CONCENTRATED FLOW BY EVIDENCE OF GULLYING OR RILLING IN DISTURBED AREAS. HAYBALES SHALL BE PLACED IN THESE AREAS. SPACED EVERY 50' IN THE UPGRADIENT SLOPE.
- 9. ALL DISTURBED AREAS SHALL BE RE-ESTABLISHED WITH "NEW ENGLAND CONSERVATION/WILDLIFE MIX" OR APPROVED EQUAL.
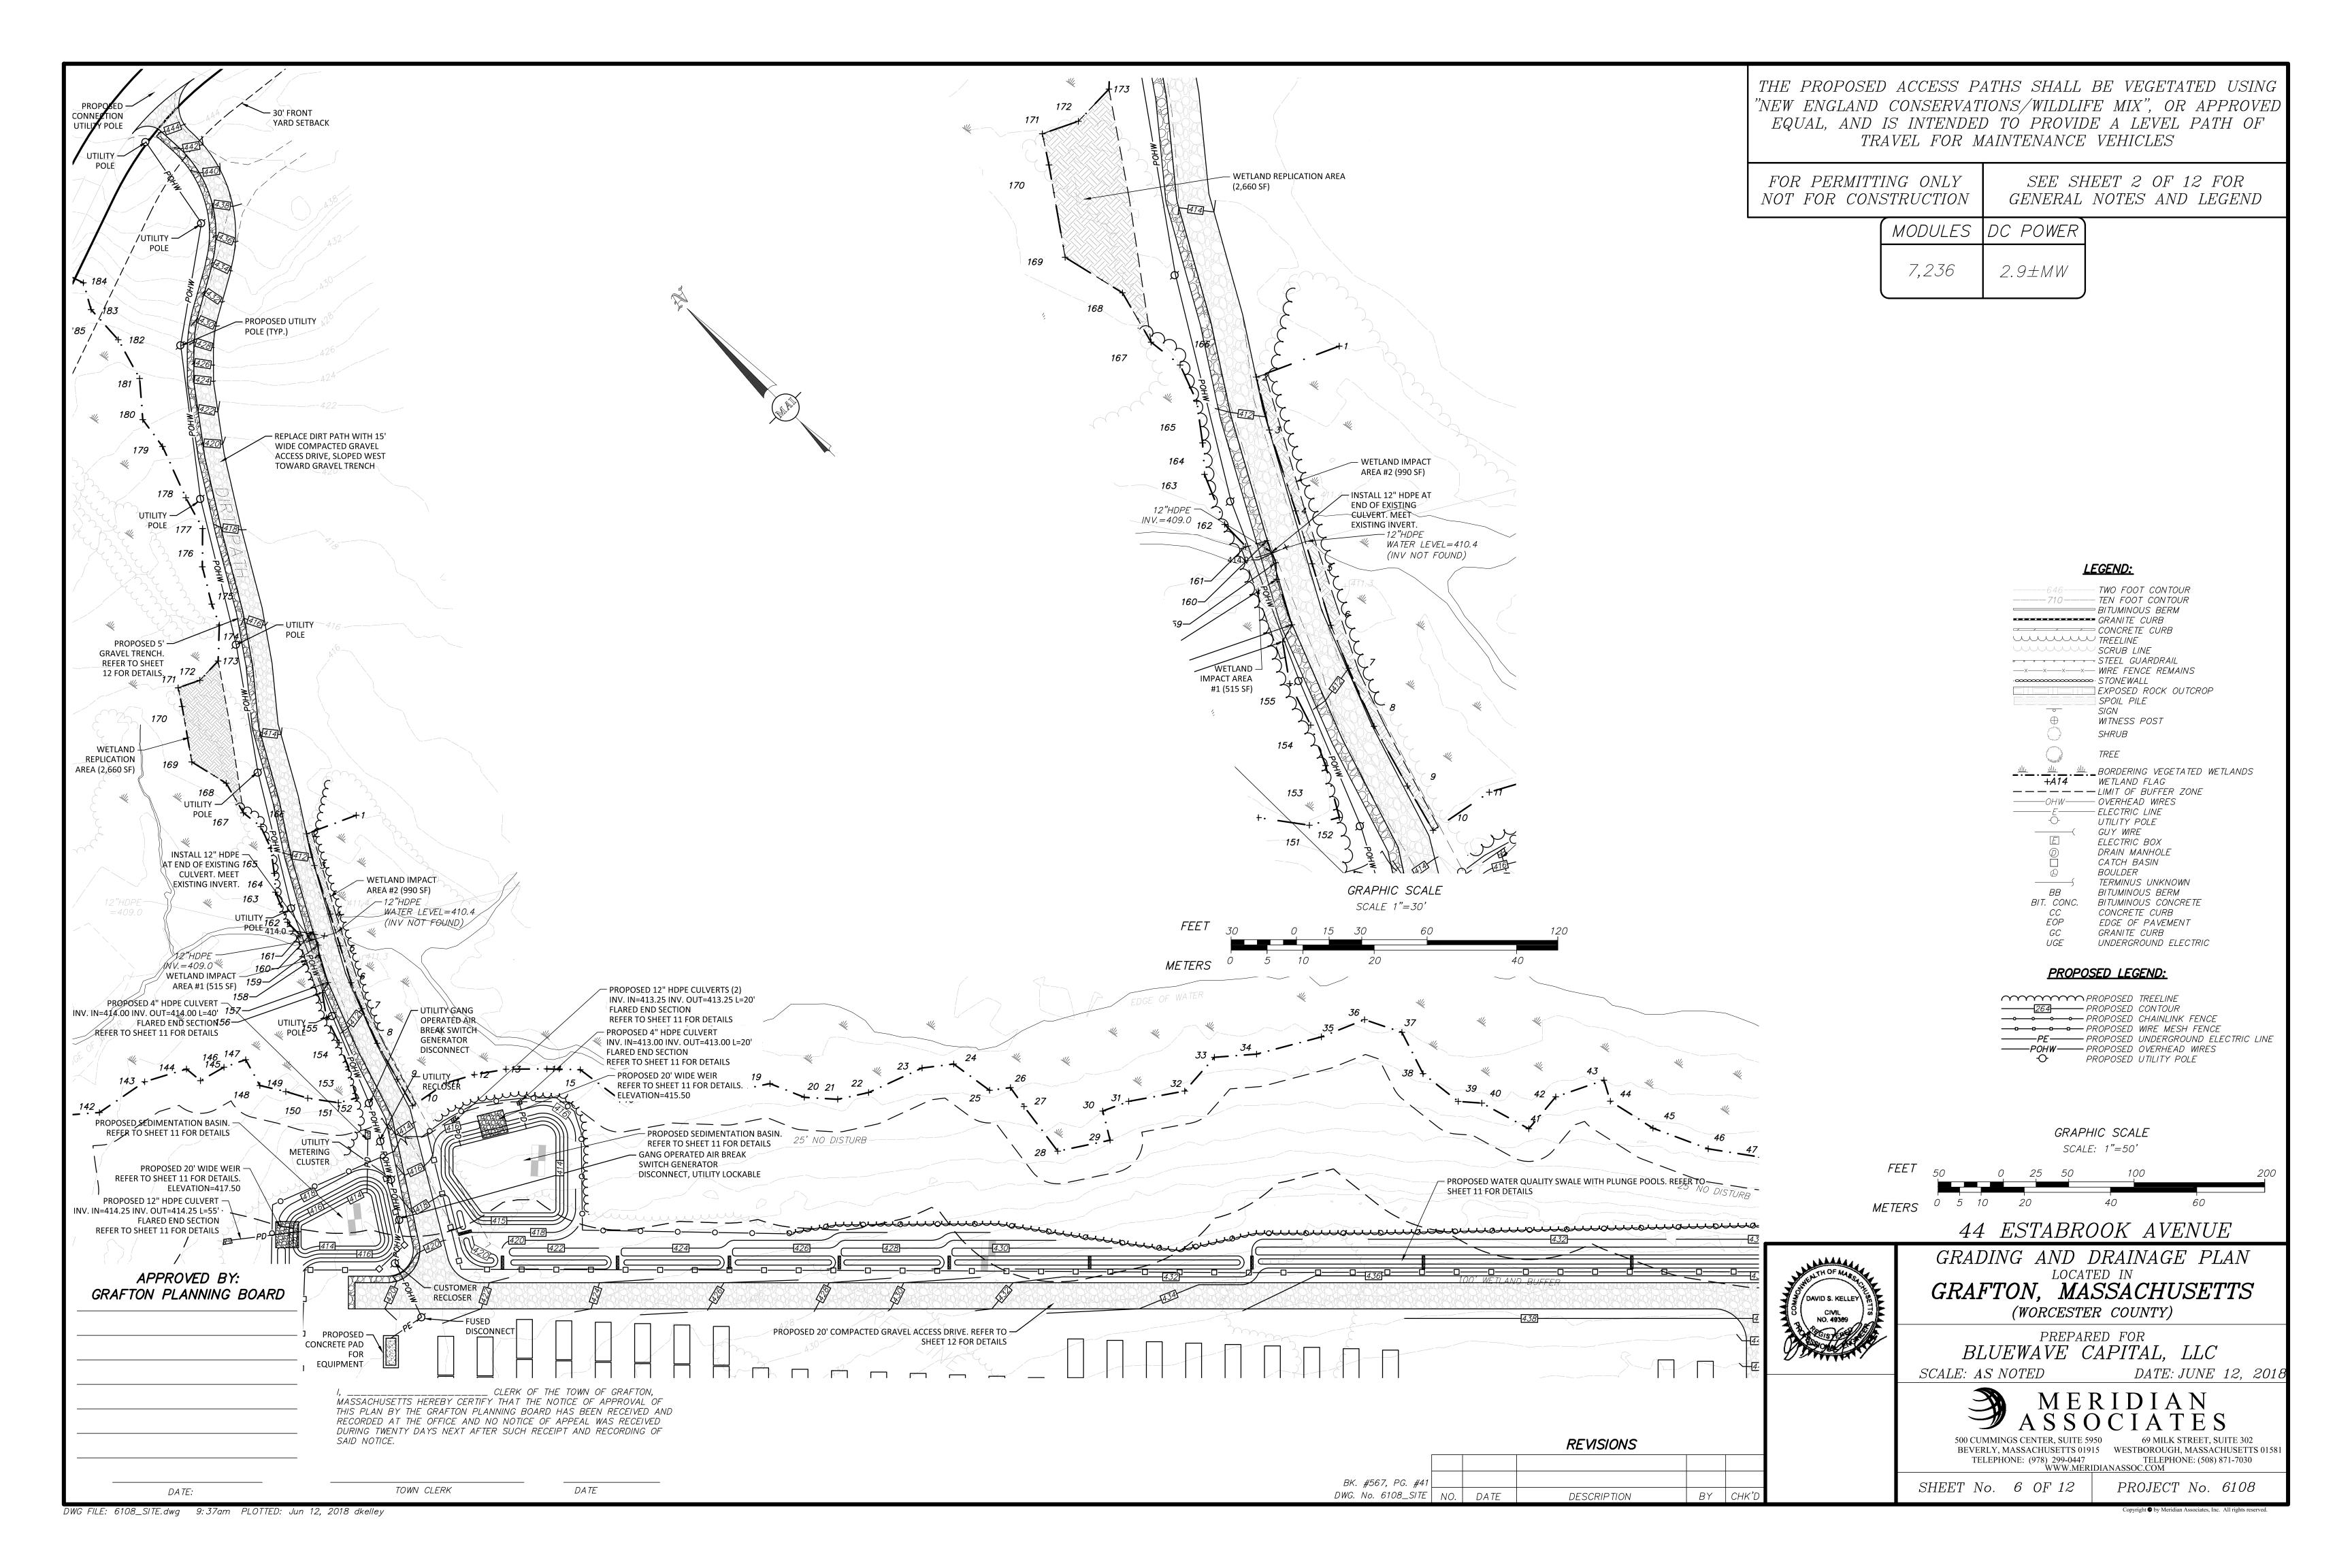
#### ESTABLISHED GUIDELINES FOR NEW <u>ENGLAND CONSERVATION/WILDLIFE MIX</u>

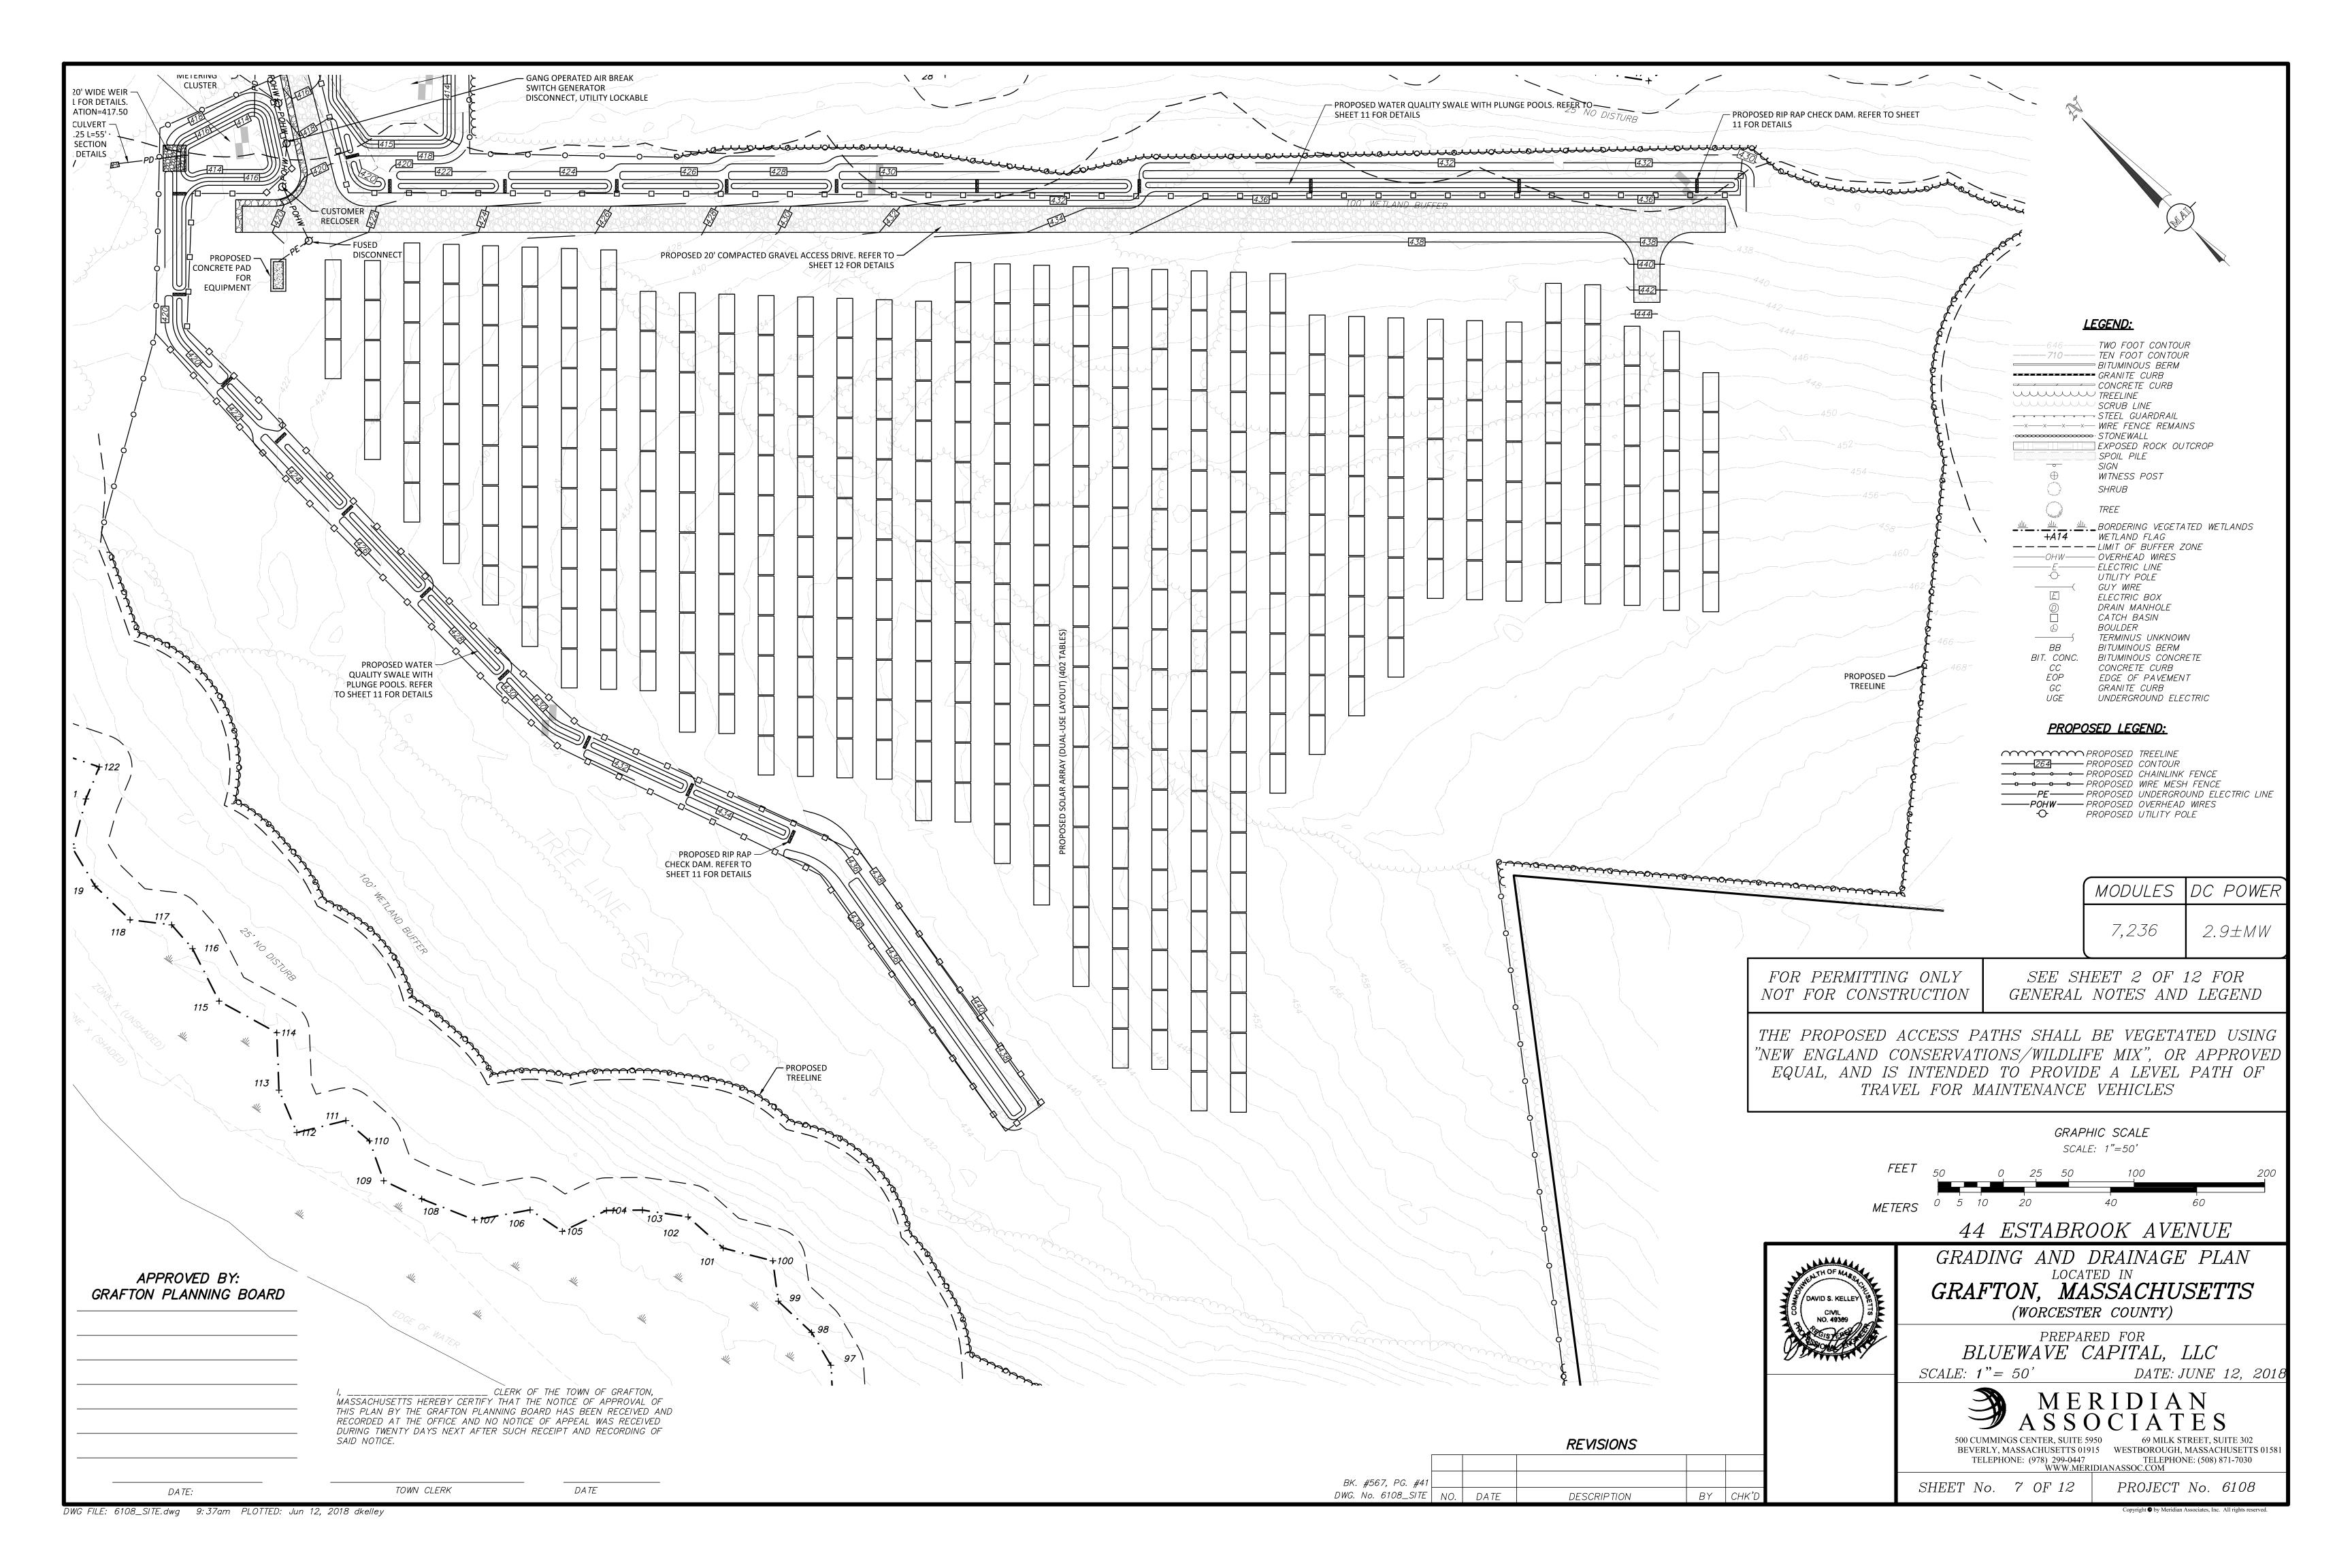THE MIX PROVIDES A PERMANENT COVER OF GRASSES, WILDFLOWERS AND LEGUMES TO PROVIDE BOTH GOOD EROSION CONTROL AND WILDLIFE HABITAT VALUE. THIS MIX IS DESIGNED TO BE A NO MAINTENANCE SEEDING, AND IT IS APPROPRIATE TO CUT AND FILL SLOPES, DETENTION BASIN SLOPES, AND DISTURBED AREAS ADJACENT TO COMMERCIAL AND RESIDENTIAL PROJECTS. ALWAYS APPLY ON CLEAN BARE SOIL. THE MIX MAY BE APPLIED BY HYDRO-SEEDING, BY MECHANICAL SPREADER, OR ON SMALL SITES IT CAN BE SPREAD BY HAND. LIGHTLY RAKE, OR ROLL TO ENSURE PROPER SEED TO SOIL CONTACT. BEST RESULTS ARE OBTAINED WITH A SPRING SEEDING. LATE SPRING THROUGH EARLY SUMMER SEEDING WILL BENEFIT WITH A LIGHT MULCHING OF WEED-FREE STRAW TO CONSERVE MOISTURE. IF CONDITIONS ARE DRIER THAN USUAL, WATERING WILL BE REQUIRED. LATE FALL AND WINTER DORMANT SEEDING REQUIRE AN INCREASE IN THE SEEDING RATE. FERTILIZATION IS NOT REQUIRED UNLESS THE SOILS ARE PARTICULARLY INFERTILE. PREPARATION OF A CLEAN WEED FREE SOIL SURFACE IS NECESSARY FOR

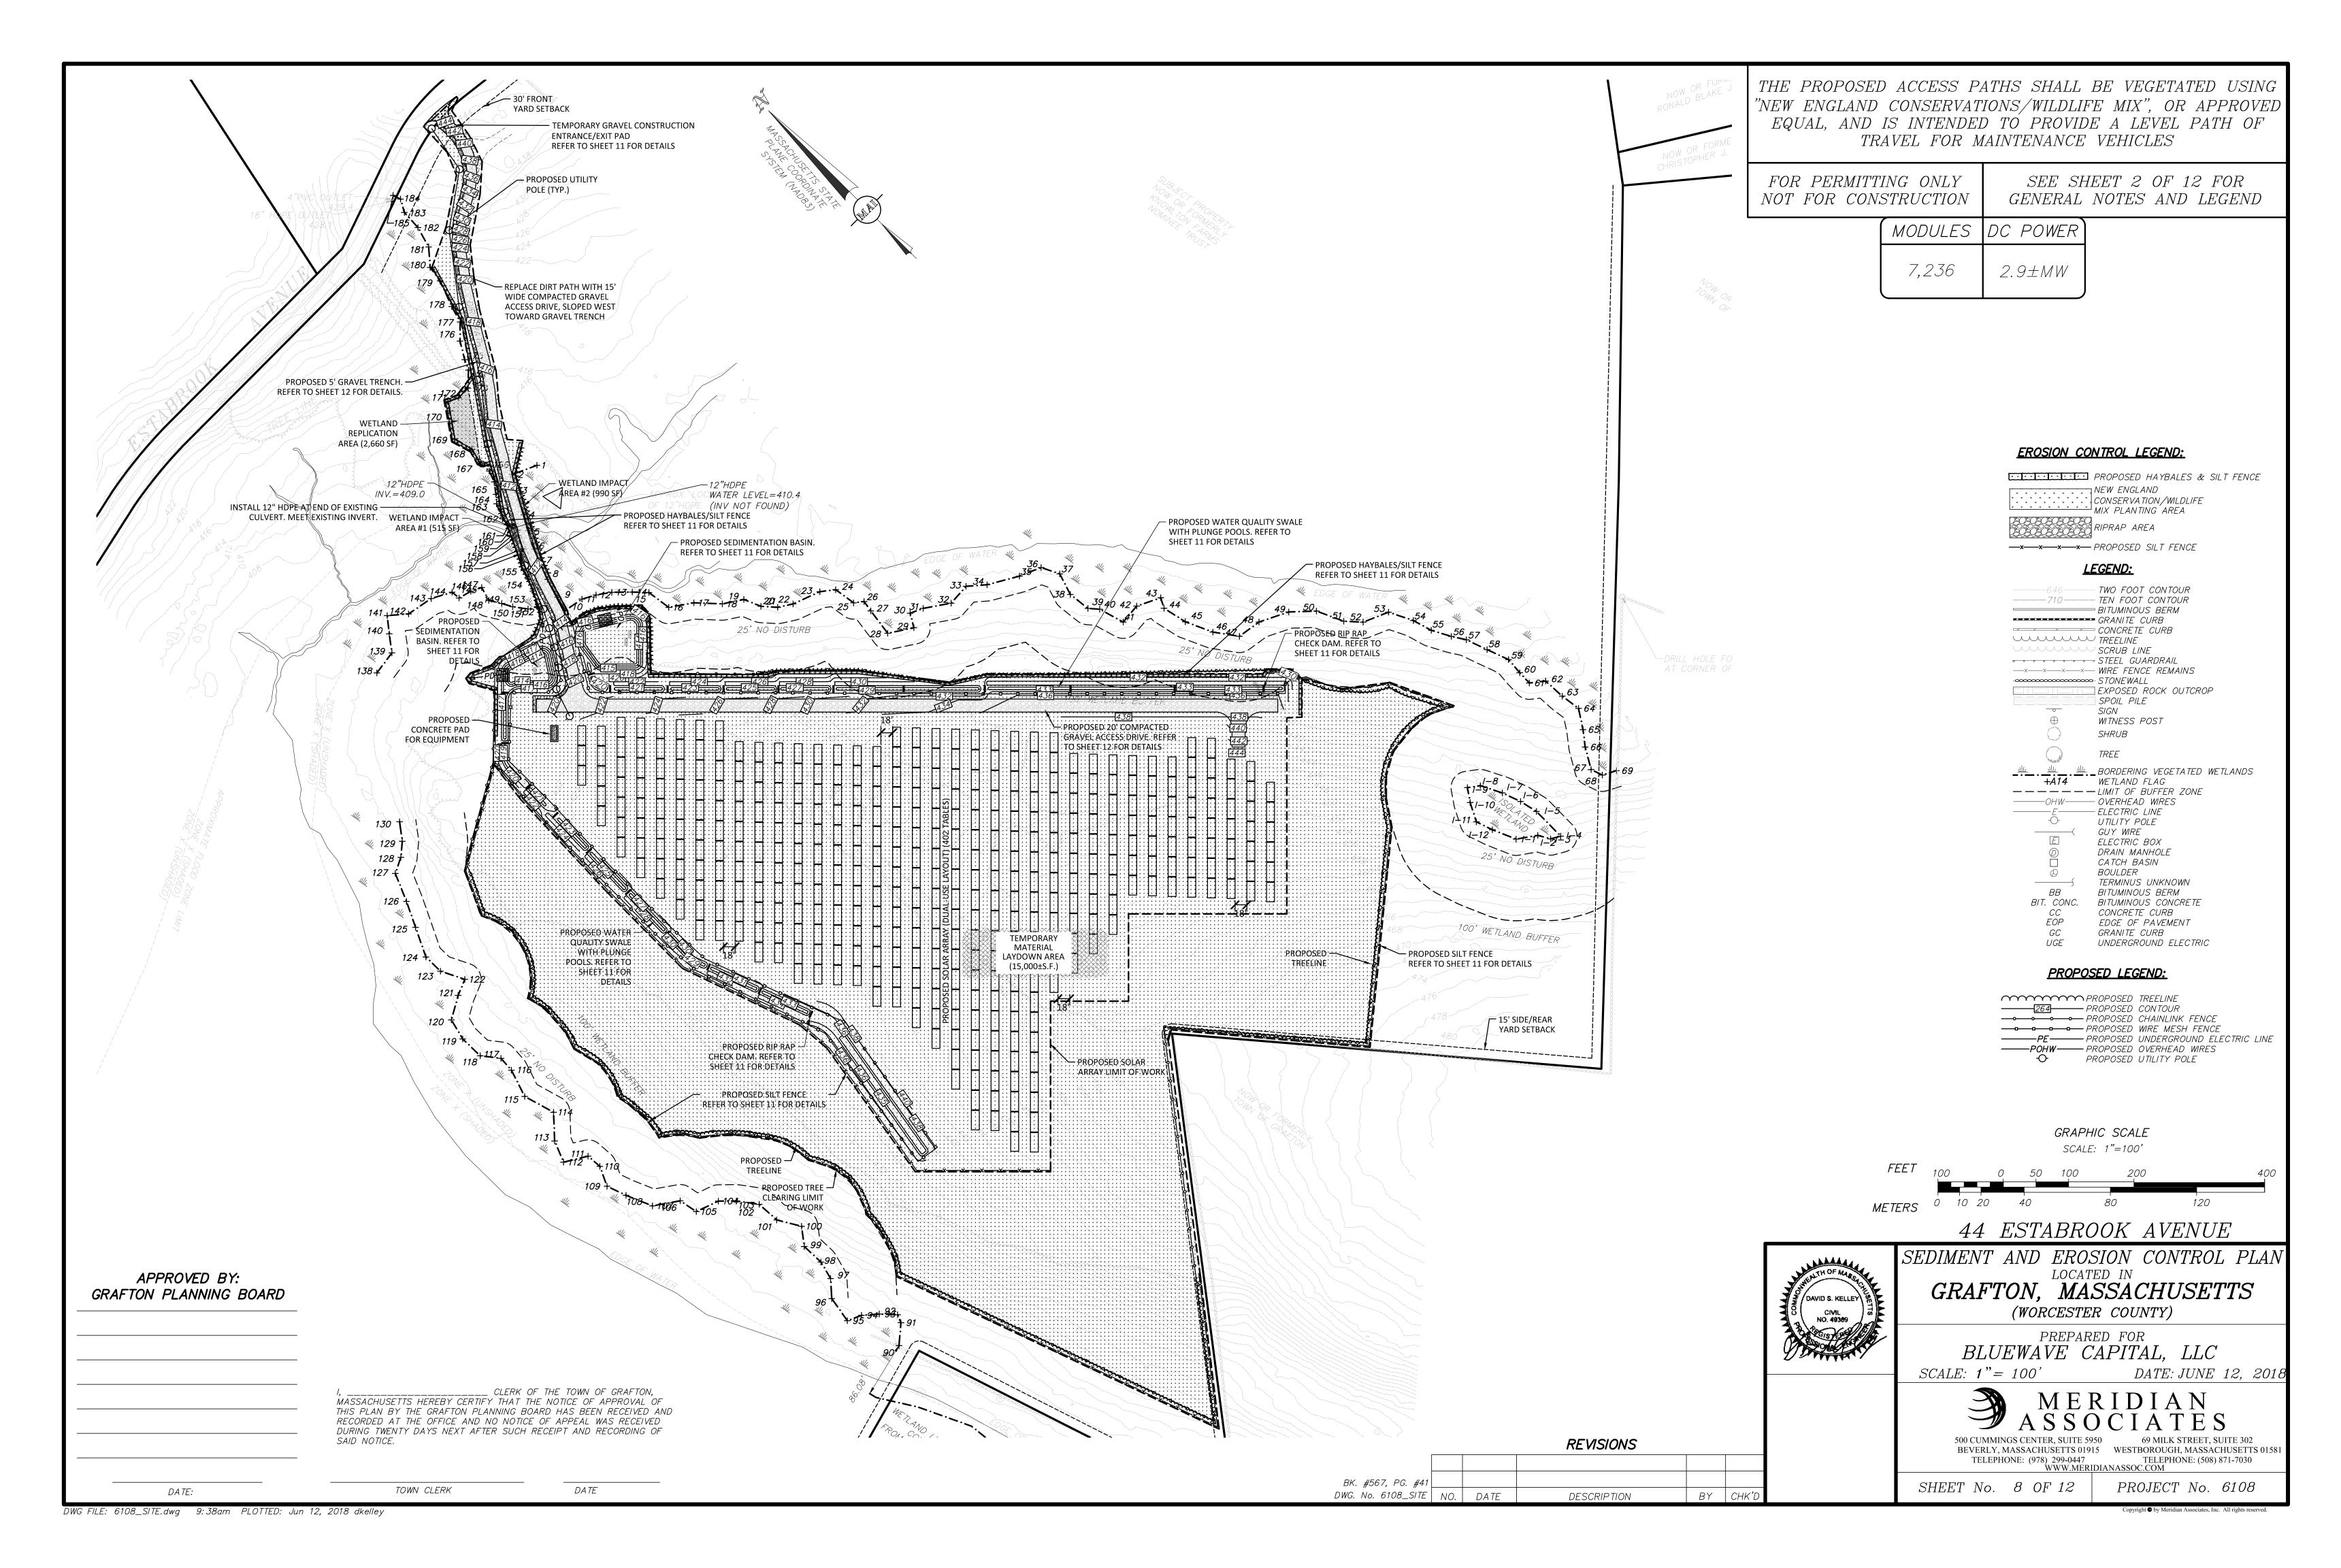ELYMUS VIRGINICUS

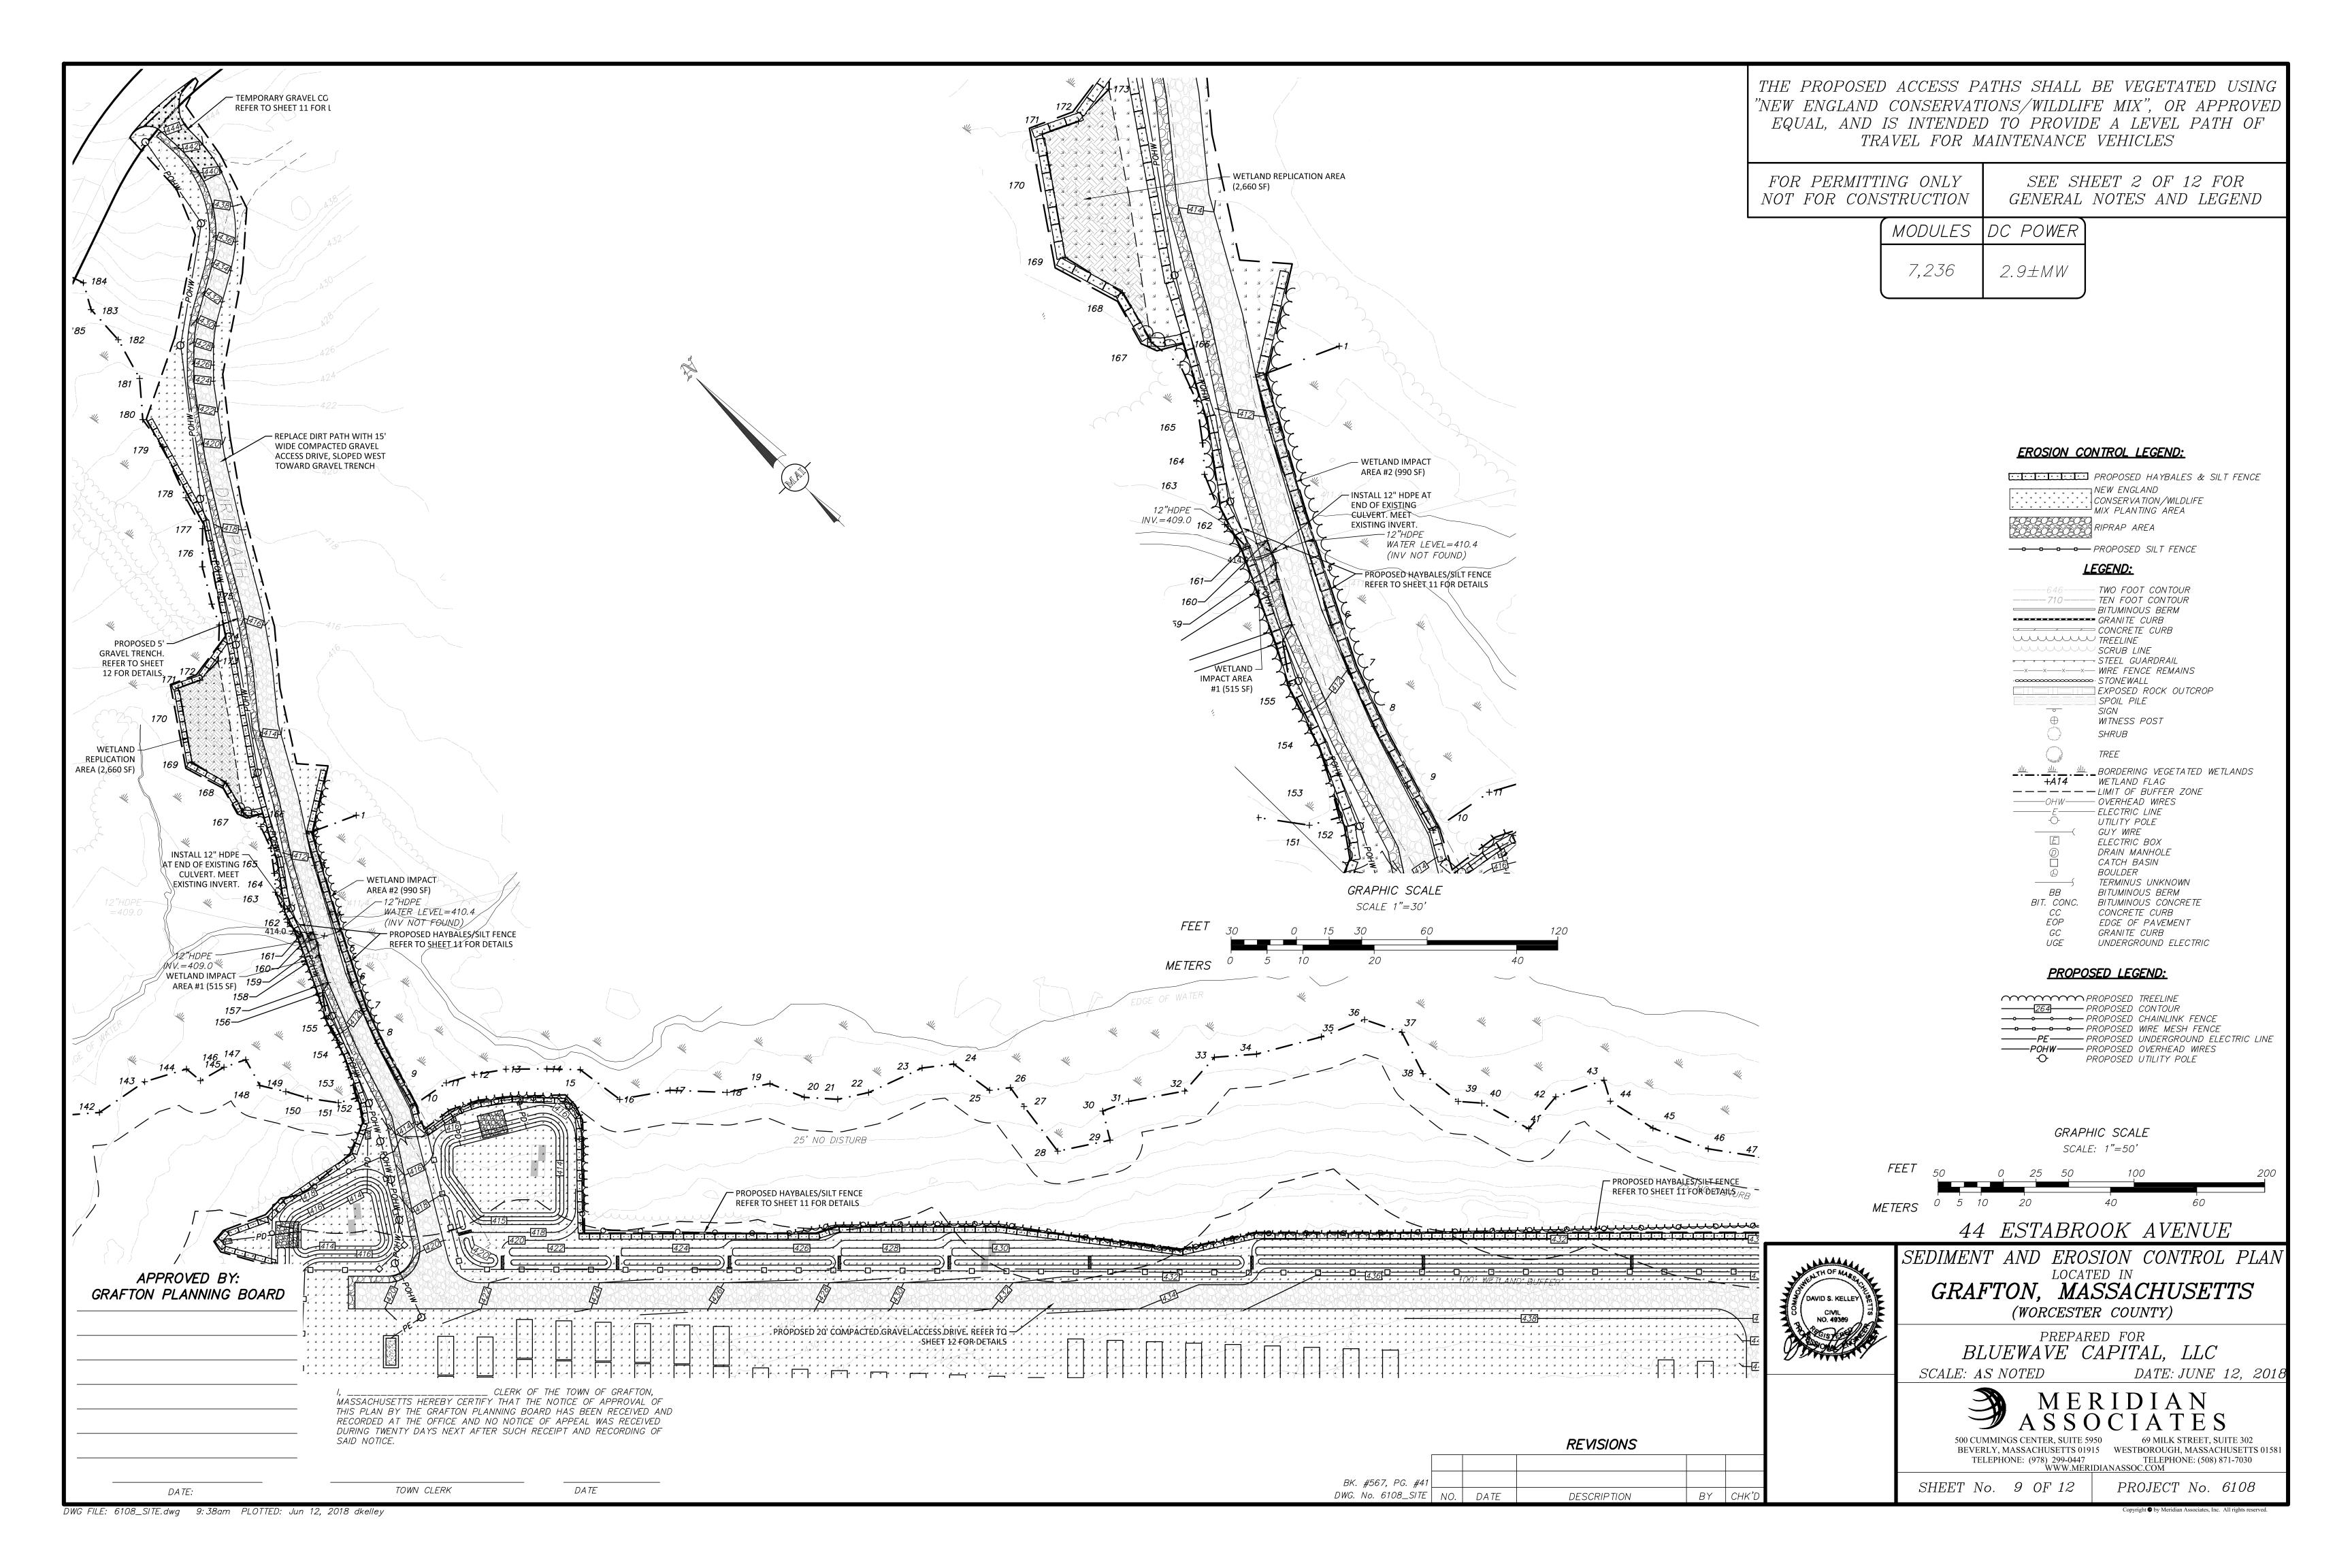OPTIMAL RESULTS.

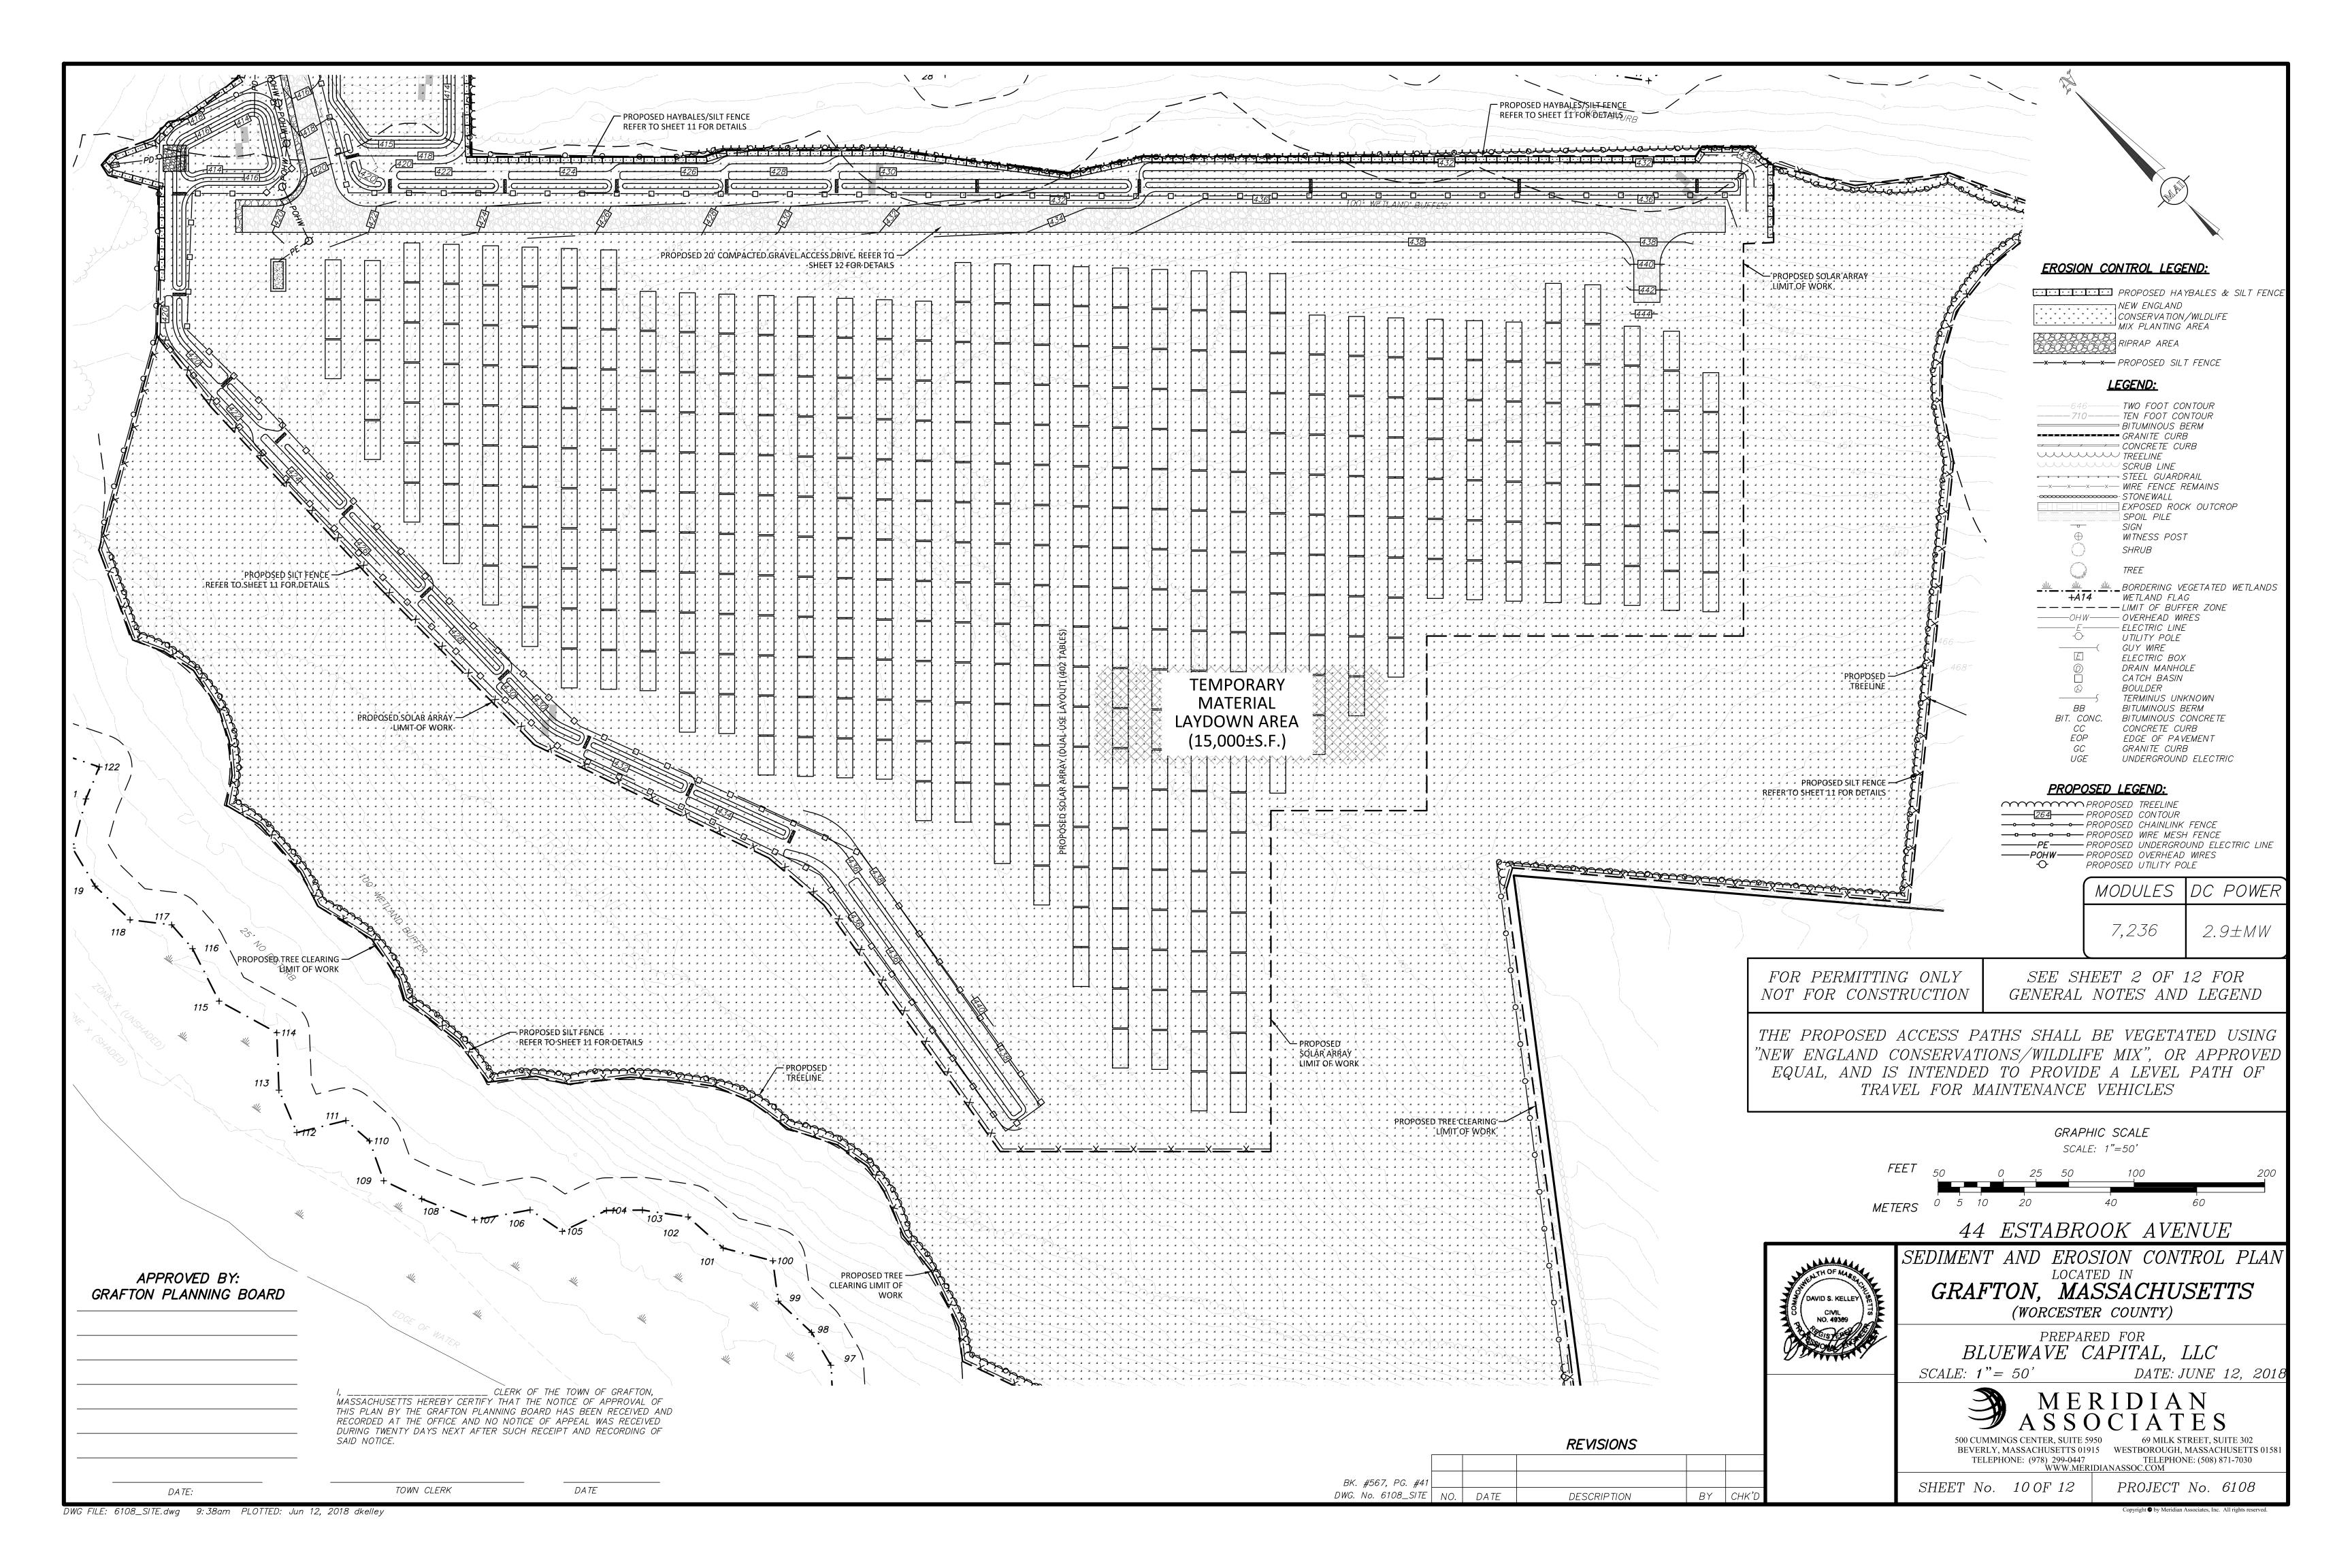- SCHIZACHYRIUM SCOPARIUM FESTUCA RUBRA
- CHAMAECRISTA FASCICULATA PANICUM CLANDESTINUM
- PANICUM VIRGATUM
- SORGHASTRUM NUTANS HELENIUM AUTUMNALE

ANDROPOGON GERARDII

- HELIOPSIS HELIANTHOIDES
- VERBENA HASTATA • ASCLEPIAS SYRIACA
- ASTER UMBELLATUS EUPATORIUM PURPUREUM
- SOLIDAGO JUNCEA ZIZIA AUREA

### SEED BED PREPARATION:

REMOVE ALL INVASIVE SPECIES, TILL EXISTING SOIL AND RAKE SMOOTH. APPLY 3" OF COMPOSTED LEAF LITTER. ALL AREAS WHERE ROOTS HAVE BEEN GRUBBED SHALL BE

### SEED APPLICATION AND RATE:

THE IDEAL PLANTING DEPTH IS 1/4-1/2". UNDER IDEAL CONDITIONS SEEDS LAYING ON THE SURFACE WILL GERMINATE. RECOMMENDED APPLICATION RATE FOR SEEDING IS 1 LBS PER 1,750 SQUARE FEET.

FOR FALL INSTALLATION, SEED BETWEEN AUGUST 15 AND SEPTEMBER 10. FOR SPRING INSTALLATION, SEED AS EARLY AS POSSIBLE SOMETIME BETWEEN APRIL 15 AND MAY 10.


#### FERTILIZATION AND SOIL REQUIREMENTS: REFER TO MANUFACTURERS RECOMMENDATIONS

GENERAL MAINTENANCE:

REFER TO MANUFACTURERS RECOMMENDATIONS


REFER TO MANUFACTURERS RECOMMENDATIONS


FOR PERMITTING ONLY NOT FOR CONSTRUCTION

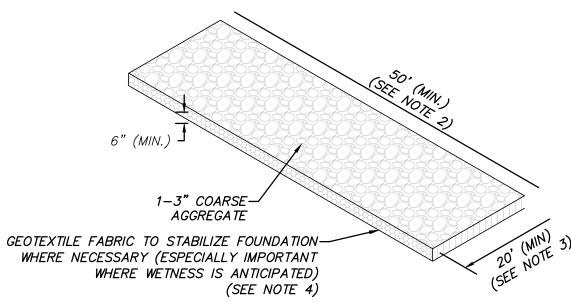

- 1. THE SOLE PURPOSE OF THIS DETAIL IS TO PROVIDE A STABLE ENTRANCE AND EXIT FROM A CONSTRUCTION SITE OR WETLAND CROSSING AND KEEP MUD AND SEDIMENT OFF PUBLIC ROADS AND WETLANDS IN ACCORDANCE WITH THE RECOMMENDATIONS STATED IN THE "MASSACHUSETTS EROSION AND SEDIMENT CONTROL GUIDELINES FOR URBAN AND SUBURBAN AREAS" AS PREPARED BY THE MASSACHUSETTS DEPARTMENT OF ENVIRONMENTAL PROTECTION.
- 2. EXTEND PAD BEYOND 50 FEET FOR HEAVY CONSTRUCTION TRAFFIC AS NECESSARY. LONGER ENTRANCES WILL PROVIDE BETTER CLEANING ACTION.
- 3. THE PAD SHALL EXTEND THE FULL WIDTH OF THE CONSTRUCTION ACCESS DRIVE.
- 4. WHERE NECESSARY, GEOTEXTILE FILTER FABRIC SHALL BE PLACED BETWEEN THE STONE FILL AND THE EARTH SURFACE BELOW THE PAD TO REDUCE THE MIGRATION OF SOIL PARTICLES FOR UNDERLYING SOIL INTO THE STONE AND VICE VERSA.

### TEMPORARY GRAVEL CONSTRUCTION TRACKING PAD

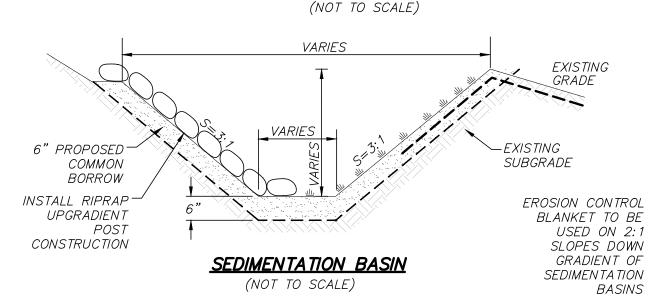


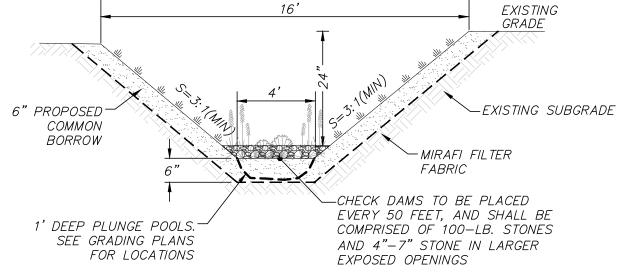

#### WATER QUALITY SWALE (NOT TO SCALE)

1. THE PLANTING PLAN WITHIN THE SWALES SHOULD INCLUDE A MIX OF HERBACEOUS PERENNIALS, SHRUBS, AND UNDERSTORY TREES THAT CAN TOLERATE INTERMITTENT PONDING, AND EXTENDED DRY PERIODS.

2. WATER QUALITY SWALES ARE TO BE SURROUNDED BY

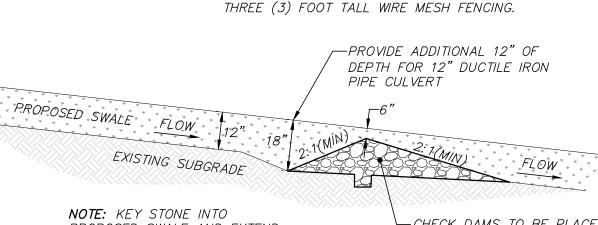


PROPOSED SWALE AND EXTEND IT BEYOND THE ABUTMENTS A MINIMUM OF 18" TO PREVENT FLOW AROUND THE CHECK DAM

-CHECK DAMS TO BE PLACED EVERY 100 FEET, AND SHALL BE COMPRISED OF 100-LB. STONES AND 4"-7" STONE IN LARGER EXPOSED OPENINGS


# TYPICAL STONE CHECK DAM

(NOT TO SCALE)

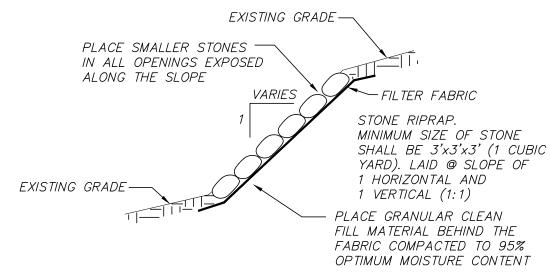


### STONE RIPRAP SLOPE PROTECTION


(NOT TO SCALE)

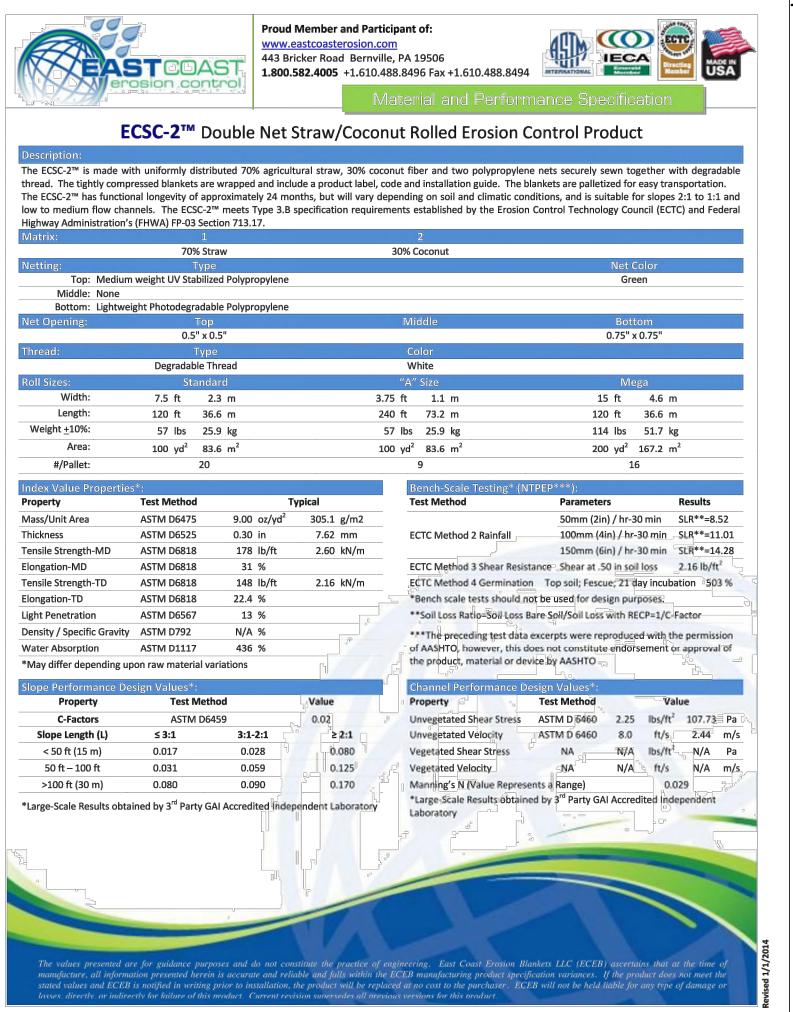

### EROSION CONTROL BLANKET. OR APPROVED EQUAL

(NOT TO SCALE)

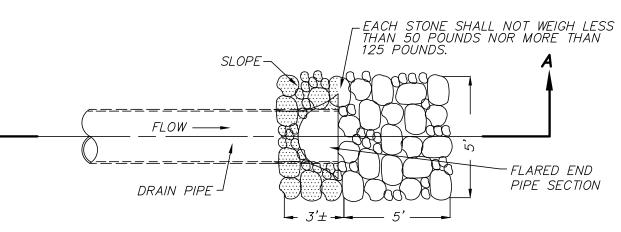

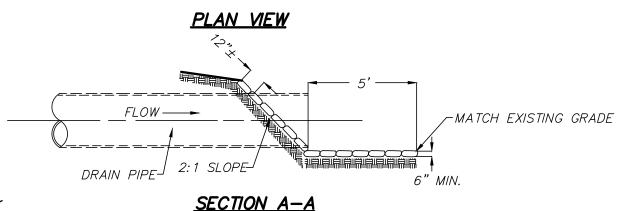

<u>STONE RIPRAP DETAIL</u>

(NOT TO SCALE)

# SET 2 HAYBALE PERPENDICULAR EVERY 50' ON SLOPES OVER 5% SPOIL FROM -BALE TRENCH STAKED HAYBALES END TO END

- AMOCO, 2130

SILT STOP

(OR EQUAL)

- WOOD STAKES 7.7'O.C.

(WORK AREA)

AMOCO, 2130 SILT

STOP (OR EQUAL),

FLOW ---

(WORK AREA)

3.5' WIDE

6"x6" TRENCH

WITH BACKFILL

IN PLACE

PLAN VIEW

CROSS SECTION

SILT FENCE

#### 1. BALES TO BE TIED WITH ORGANIC FIBER TWINE ONLY NO PLASTIC OR WIRE.

2. HAYBALES TO BE SECURED WITH A MINIMUM OF TWO (2) 1" x 1" WOODEN STAKES PER BALE DRIVEN 18" MIN. INTO

> HAYBALE WITH SILT FENCE BARRIER (NOT TO SCALE) DWG. No. 6108\_DET | NO. | DATE

# REVISIONS

DESCRIPTION

BY

CHK'I

#### GENERAL SEQUENCE OF CONSTRUCTION:

CONTACT DIGSAFE (888.344.7233) AND OBTAIN CLEARANCE AT LEAST 72 HOURS BEFORE INITIATING ANY ÉXCAVATION.

#### <u>SITE PREPARATION SHALL BE CONDUCTED IN TWO (2) PHASES</u> IN ORDER TO MAXIMIZE EROSION AND SEDIMENTATION CONTROL

- ESTABLISH PHASE 1 EROSION AND SEDIMENTATION CONTROL MEASURES (HAYBALES & SILT FENCE) AS DEPICTED HEREIN AND AROUND AREAS OF DISTURBANCE AND MAINTAIN THROUGHOUT CONSTRUCTION IN ACCORDANCE WITH LOCAL REQUIREMENTS. PERFORM INSPECTIONS, REPAIR IF NECESSARY, AND DOCUMENT AFTER EACH PRECIPITATION EVENT OF 0.25-INCHES OR GREATER.
- PRIOR TO CONSTRUCTION, THE CONTRACTOR SHALL CONSTRUCT THE TEMPORARY GRAVEL CONSTRUCTION ENTRANCE/EXIT PAD AT BOSTON POST ROAD. THE PAD SHALL CONSIST OF 1"-3" COARSE AGGREGATE WITH MINIMUM DIMENSIONS OF 50' (LENGTH) x 20' (WIDTH) x 6" (DEPTH) AND SET ON GEOTEXTILE FABRIC TO STABILIZE FOUNDATION (ESPECIALLY IMPORTANT WHERE WETNESS IS ANTICIPATED).
- PERFORM LIMITED CLEARING ACTIVITIES IN ORDER TO CONSTRUCT GRAVEL ACCESS DRIVE AND TURNAROUND.
- SITE PREPARATION SHALL INCLUDE CLEARING AND REMOVAL OF EXISTING VEGETATION AND DEBRIS. ALL TREES, STUMPS, BRUSH, SHRUBS, ROOTS, GRASS, WEEDS, RUBBISH, BITUMINOUS PAVEMENT, STONES LARGER THAN 2-IN. IN THE LARGEST DIAMETER AND OTHER OBJECTIONABLE MATERIAL SHALL BE REMOVED AND DISPOSED OF FROM AREAS TO BE FILLED AND COMPACTED. AREAS OUTSIDE OF THE LIMITS OF WORK SHALL BE PROTECTED FROM DAMAGE. NO STUMPS, TREES, LIMBS, OR BRUSH SHALL BE BURIED IN ANY FILLS OR EMBANKMENTS.
- 6. CONSTRUCT SEDIMENTATION BASINS (SHOWN ON PLANS).
- GRUBBING OF AREAS WITHIN THE PROPOSED FENCE AND GRADING AREAS ONLY SHALL BE CONDUCTED AFTER THE INSTALLATION OF THE SEDIMENTATION BASIN.
- FOR AREAS WHERE NO GRADING IS PROPOSED. REPAIR UNEVEN AREAS WITHIN LIMITS OF THE SOLAR DEVELOPMENT. AS NECESSARY TO CREATE A TOLERABLE GROUND SURFACE. GENERAL TOLERANCE FOR ALLOWABLE GROUND SLOPE IS TWO FOOT VERTICAL CHANGE OVER A 20 FOOT HORIZONTAL RUN [NOTE THAT THIS REFERS TO THE ALLOWABLE LONGITUDINAL SLOPE (I.E., ALONG THE CONTOUR) AND NOT THE INCLINATION OF THE EXPOSURE (I.E., PERPENDICULAR TO THE CONTOUR)].
- UPON SIGNS OF CONCENTRATED FLOW BY EVIDENCE OF GULLYING OR RILLING IN DISTURBED AREAS, HAYBALES, OR APPROVED EQUAL, SHALL BE PLACED IN THESE AREAS, SPACED EVERY 50' IN THE UPGRADIENT SLOPE.


#### PHASE II:

10. ESTABLISH PHASE II EROSION AND SEDIMENTATION CONTROL MEASURES (HAYBALES & SILT FENCE) AS DEPICTED HEREIN AND AROUND AREAS OF DISTURBANCE AND MAINTAIN THROUGHOUT CONSTRUCTION IN ACCORDANCE WITH LOCAL REQUIREMENTS. PERFORM INSPECTIONS, REPAIR IF NECESSARY, AND DOCUMENT AFTER EACH PRECIPITATION EVENT OF 0.25-INCHES OR GREATER (PHASE I EROSION CONTROL IS TO REMAIN IN PLACE AND MAINTAINED AS DESCRIBED ABOVE).

#### REPEAT STEPS 5, 6, 7, 8 AND 9 ABOVE FOR PHASE II.

- . RECEIVE AND STAGE MATERIALS. RE-LOCATE COMPONENTS (E.G., CONDUIT. WIRING AND POSTS) TO SOLAR DEVELOPMENT AREA AS THEY ARE REQUIRED.
- 12. INSTALL RACKING SYSTEM, MOUNT THE PV PANELS ON FRAME AT THE SPECIFIED ORIENTATION AND EXPOSURE (TO BE PROVIDED BY PROJECT MEP PRIOR TO CONSTRUCTION).
- 13. RUN UNDERGROUND FLECTRICAL CONDUIT TO PV FRAMES AND INSTALL PANEL WIRING. (LOCATION TO BE PROVIDED BY PROJECT MEP PRIOR TO CONSTRUCTION)
- 14. INSTALL PV COMBINER BOXES WITH FLEXIBLE CONNECTIONS TO CONNECT PV PANELS TO CONDUIT. (LOCATION TO BE PROVIDED BY PROJECT MEP PRIOR TO
- 15. CONSTRUCT CONCRETE EQUIPMENT PADS. INSTALL AND CONNECT GROUND MOUNTED ELECTRICAL EQUIPMENT. A DISCONNECT LOCATION WILL BE ON THE OUTSIDE ON THE NARROWEST SIDE OF THE PLATFORM.
- 16. RUN CONDUIT FROM THE CONCRETE EQUIPMENT PADS TOWARDS THE POINT OF INTERCONNECTION AS DEPICTED ON THE SITE PLAN.
- 17. INSTALL RISER POLES AND UTILITY POLES WITH ELECTRICAL COMPONENTS AND OVERHEAD WIRING FROM THE POINT OF INTERCONNECTION TO THE ARRAY.
- 18. CONSTRUCT ALL 7' HIGH CHAIN LINK FENCE AND GATES. (SHOWN ON PLAN)
- 19. ALL DISTURBED AREAS SHALL BE RE-ESTABLISHED WITH "NEW ENGLAND CONSERVATION/WILDLIFE MIX" (DEPICTED HEREIN). IN THE EVENT THAT THE SEEDING FALLS OUTSIDE OF THE RECOMMENDED SEEDING DATES, DISTURBED AREAS SHALL BE RE-ESTABLISHED USING ALTERNATIVES METHODS AS APPROVED BY THE PROJECT SITE ENGINEER.
- 20. REMOVE ANY ACCUMULATED SEDIMENT FROM THE SEDIMENTATION BASINS. THE SEDIMENTATION BASINS ARE TO BE LINED WITH RIPRAP AND REMAIN IN PLACE AFTER CONSTRUCTION.
- 21. RE-PAVE THE BITUMINOUS CONCRETE AT THEN ENTRANCE TO THE SITE. (SHOWN ON PLANS)
- 22. UPON COMPLETION OF CONSTRUCTION ACTIVITIES WITHIN THE LIMIT OF WORK, THE CONTRACTOR SHALL EFFECTIVELY AND PERMANENTLY STABILIZE THE SITE.

## 44 ESTABROOK AVENUE

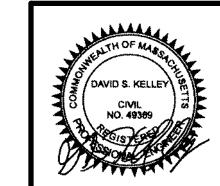

LOCATED IN GRAFTON, MASSACHUSETTS

(WORCESTER COUNTY)

PREPARED FOR BLUEWAVE CAPITAL, LLC


DATE: JUNE 12, 2018 SCALE: AS NOTED



TELEPHONE: (978) 299-0447

BEVERLY, MASSACHUSETTS 01915 WESTBOROUGH. MASSACHUSETTS 01581 TELEPHONE: (508) 871-7030

SHEET No. 11 OF 12

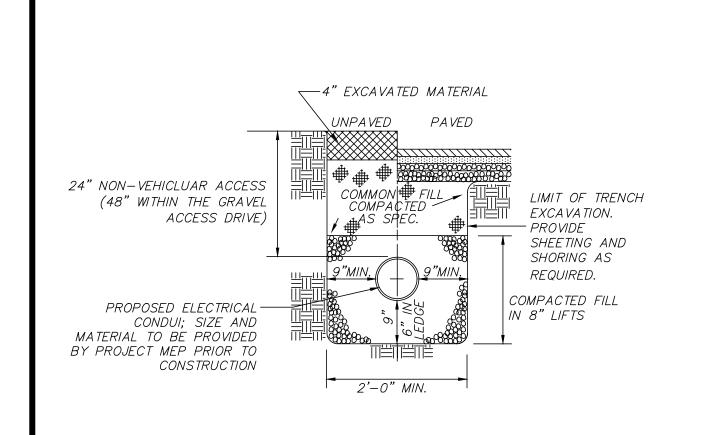

#### FILL SPECIFICATION

No. 100

No. 200 (FINES)

FINE AGGREGATE SHALL CONSIST OF HARD, DURABLE SAND. FRE OF CLAY. ORGANIC MATTER. SURFACE COATINGS, AND OTHER DELETERIOUS MATERIALS. SOIL FINER THAN THE No. 200 SIEVE (THE FINES) SHALL BE NONPLASTIC. FINE AGGREGATÈ FILL SHALL CONFORM TO THE REQUIREMENTS OF THE 1988 MASS. HIGHWAY DEPT. STANDARD SPECIFICATIONS FOR HIGHWAYS AND BRIDGES, SECTION M4.02.02A (2010 SUPPLEMENTAL SPECIFICATIONS). FINE AGGREGATE SHALL MEET THE FOLLOWING GRADATION REQUIREMENTS:


SIEVE SIZE PERCENT PASSING BY WEIGHT 3/8 INCH 100 95 - 100 45 – 80 10 - 30 No. 50


FINE AGGREGATE FILL SHALL BE COMPACTED IN MAXIMUM 9-INCH-THICK LOOSE LIFTS TO AT LEAST 95 PERCENT OF THE MAXIMUM DRY DENSITY DETERMINED IN ACCORDANCE WITH ASTM D1557 (MODIFIED AASHTO COMPACTION)

2 - 10

0 – 3


#### TYPICAL CONDUIT TRENCH DETAIL (NOT TO SCALE)

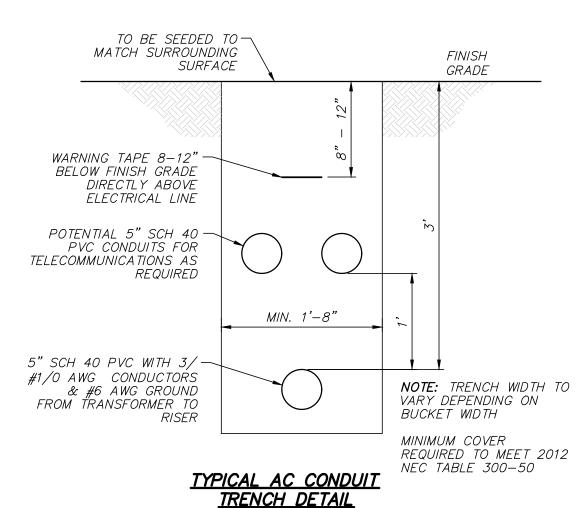

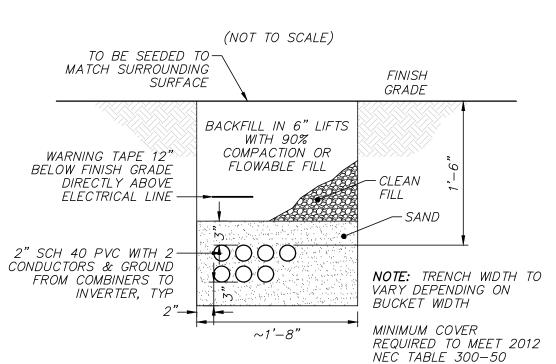


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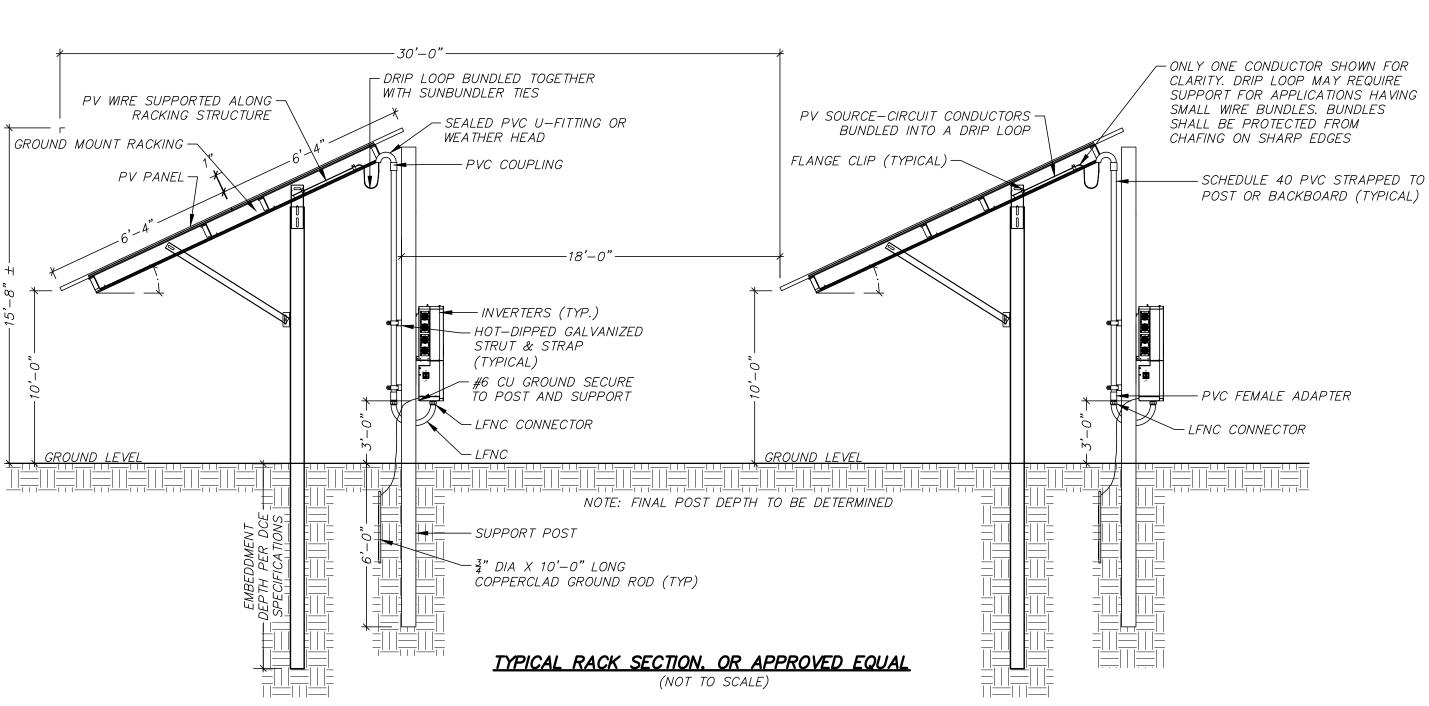
TYPICAL DC CONDUIT TRENCH DETAIL (NOT TO SCALE)

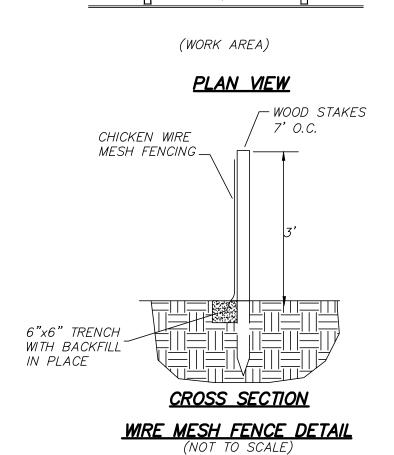

- CHICKEN WIRE MESH FENCING

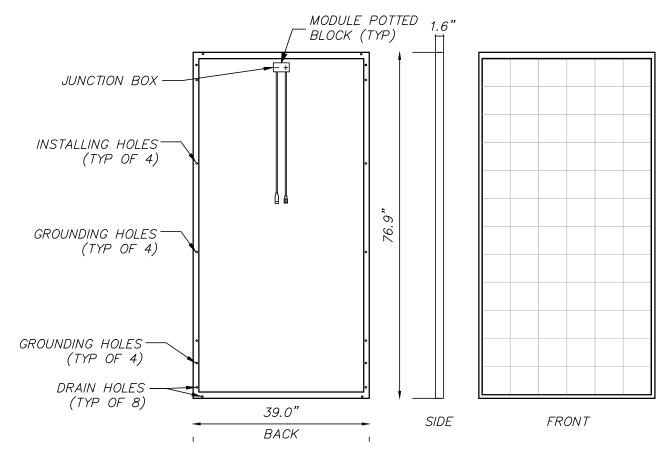

#### TYPICAL PV MODULE. OR APPROVED EQUAL (NOT TO SCALE)



BORROW SUBGRADE

GRAVEL STONE TRENCH DETAIL


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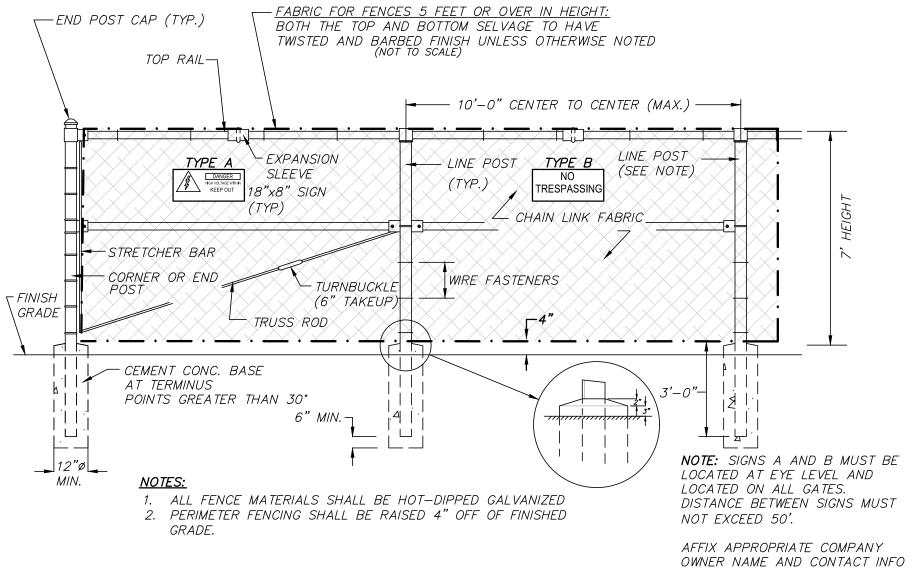
\_1/2" WASHED

STONE

COMPACTED IN 6" LIFTS

PLANTING MAINTENANCE NOTES: LANDSCAPING SHALL BE PROPERLY MAINTAINED, ANY DEAD OR DISEASED PLANTINGS SHALL BE REPLACED IN THE NEXT IMMEDIATE SPRING OR FALL PLANTING SEASON.




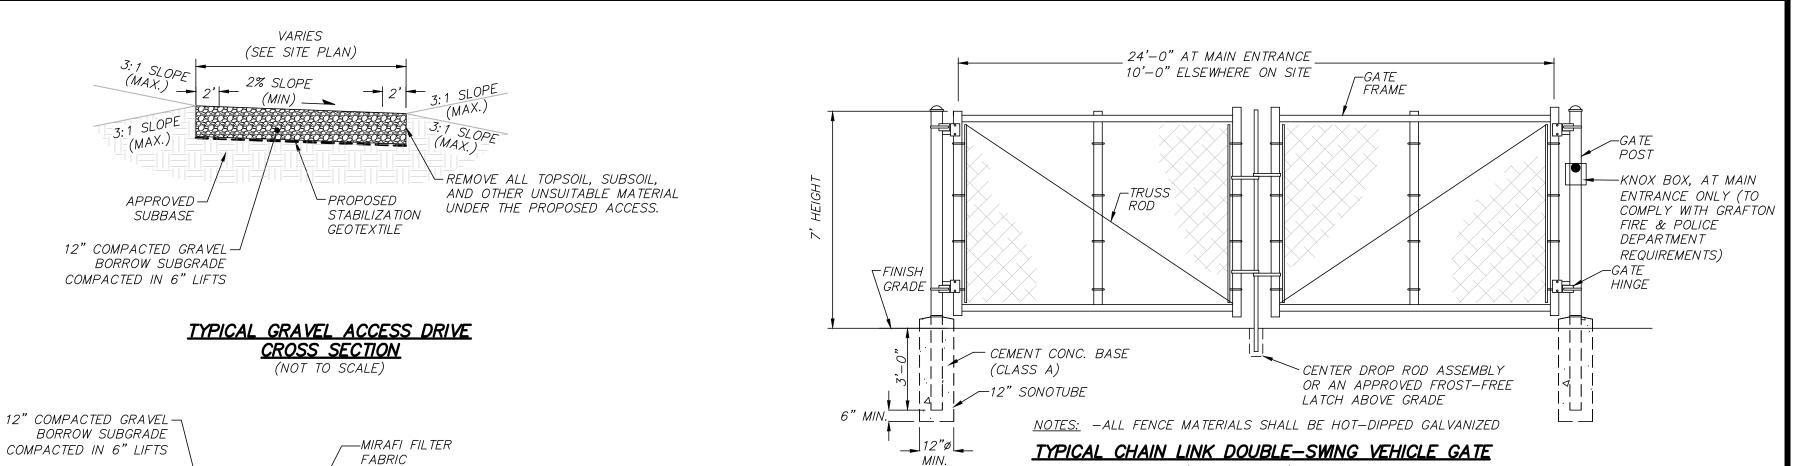

(NOT TO SCALE)

TYPICAL CHAIN LINK FENCE W/ TOPRAIL DETAIL OR APPROVED EQUAL (NOT TO SCALE)

## 44 ESTABROOK AVENUE

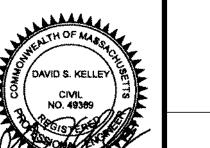

**REVISIONS** 

SITE DETAILS LOCATED IN GRAFTON, MASSACHUSETTS

(WORCESTER COUNTY)

PREPARED FOR BLUEWAVE CAPITAL, LLC



BEVERLY, MASSACHUSETTS 01915 WESTBOROUGH, MASSACHUSETTS 01581 TELEPHONE: (978) 299-0447 TELEPHONE: (508) 871-7030

SHEET No. 12 OF 12

SCALE: AS NOTED

PROJECT No. 6108

DATE: JUNE 12, 2018

DECAL TO BOTH SIGNS A AND B.

DWG FILE: 6108\_DET.dwg 9:38am PLOTTED: Jun 12, 2018 dkelley

DWG. No. 6108\_DET | NO. | DATE DESCRIPTION BY CHK'L